GENERAL NOTES:

- THIS PRODUCT HAS BEEN TESTED, ANALYZED & APPROVED FOR DESIGN PRESSURES NOT TO EXCEED THOSE SHOWN IN THE "ALLOWABLE DESIGN PRESSURE TABLE(S)".
- 2. OPENINGS, BUCKING & BUCKING FASTENERS MUST BE PROPERLY DESIGNED & INSTALLED TO TRANSFER WIND LOADS TO THE STRUCTURE.
- 3. ALL HARDWARE & FASTENERS SHALL BE IN ACCORDANCE WITH THESE DRAWINGS & SHALL NOT VARY UNLESS SPECIFICALLY MENTIONED ON THE DRAWINGS. SPECIFIED ANCHOR EMBED TO BASE MATERIAL SHALL BE BEYOND WALL FINISH OR STUCCO.
- 4. THIS PRODUCT HAS BEEN DESIGNED IN ACCORDANCE WITH AND MEETS THE REQUIREMENTS OF THE FLORIDA BUILDING CODE (FBC) INCLUDING HIGH VELOCITY HURRICANE ZONES (HVHZ) & IS LARGE MISSILE IMPACT RATED.
- IMPACT SHUTTERS ARE NOT REQUIRED WITH THIS PRODUCT.
- ALL ANCHORS SECURING PRODUCT FRAMES TO PRESSURE TREATED BUCKS OR WOOD FRAMING SHALL BE CAPABLE OF RESISTING CORROSION CAUSED BY THE PRESSURE TREATING CHEMICALS IN THE WOOD.
- DETERMINE THE POSITIVE & NEGATIVE DESIGN LOADS TO USE WHEN REFERENCING THESE DOCUMENTS IN ACCORDANCE WITH THE GOVERNING CODE AND GOVERNING WIND VELOCITY. FOR WIND LOAD CALCULATIONS IN ACCORDANCE WITH THE FLORIDA BUILDING CODE, A DIRECTIONALITY FACTOR OF Kd = 0.85 MAY BE APPLIED PER THE ASCE-7 STANDARD.
- 8. MATERIALS, INCLUDING BUT NOT LIMITED TO STEEL SCREWS, THAT COME INTO CONTACT WITH OTHER DISSIMILAR MATERIALS SHALL MEET THE REQUIREMENTS OF FLORIDA BUILDING CODE.
- 9. TO THE BEST OF OUR KNOWLEDGE, THE PRODUCT SHOWN HEREIN IS QUALITY ASSURED BY A FLORIDA STATE APPROVED CERTIFICATION/OA ENTITY & SHALL BE LABELED IN ACCORDANCE WITH THE FBC AND THE FLORIDA DEPARTMENT OF BUSINESS & PROFESSIONAL REGULATION SPECIFICATIONS. THESE DRAWINGS SHOW ALL APPLICABLE ELEVATION, COMBINATION, INSTALLATION & COMPARATIVE ANALYSIS CONDITIONS AS DETERMINED THROUGH TESTING & ENGINEERING RATIONAL ANALYSIS. PRODUCT ASSEMBLY SHALL BE IN ACCORDANCE WITH THESE DRAWINGS. THE MANUFACTURER'S QUALITY ASSURANCE SPECIFICATIONS & TESTING
- 10. CERTIFICATION OF THIS PRODUCT SHALL BE CONSIDERED VOID IF IT IS INSTALLED WITHOUT A BUILDING PERMIT FROM THE APPLICABLE LOCAL BUILDING DEPARTMENT OR IF IT IS INSTALLED BY ANYONE OTHER THAN A LICENSED CONTRACTOR EXPERIENCED WITH INSTALLATIONS OF THIS TYPE OF PRODUCT.
- 11. ALL WOOD MEMBERS OF THIS PRODUCT THAT MAY POSSIBLY COME INTO CONTACT WITH MASONRY OR CONCRETE SUBSTRATES, ARE SUBJECT TO MOISTURE &/OR ARE SUBJECT TO THE OUTSIDE ENVIRONMENT SHALL BE OF AN APPROVED DURABLE SPECIES OR BE TREATED IN AN APPROVED METHOD WITH AN APPROVED PRESERVATIVE PER FBC REQUIREMENTS.

EVALUATION OF THIS PRODUCT IS BASED ON APPLICABLE STANDARDS AND/OR INFORMATION & RESULTS FROM APPLICABLE TEST REPORTS. THE FLORIDA BUILDING CODE VERSION CONSIDERED WITH THIS EVALUATION WAS THAT IN FORCE AT THE TIME OF THE EVALUATION. IN THE EVENT OF CODE VERSION CHANGES/UPDATES OR IN THE EVENT THAT NEW OR ADDITIONAL TESTING IS COMPLETED ON THIS PRODUCT, PRIOR TO STATING CODE COMPLIANCE WITH THE STATE, THE MANUFACTURER SHALL CONFIRM WITH THE EVALUATION ENGINEER OF RECORD THAT EVERYTHING SPECIFIED HERE-IN IS CURRENT WITH ALL CURRENT TESTING, CODES AND APPLICABLE

FRAME AND	CHOR REQUIREMENTS TABLE		
OPENING TYPE (SUBSTRATE)	FRAME/HINGE/STRIKE/CLIP TO OPENING FASTENER TYPE	MINIMUM EMBED	MINIMUM EDGE DIS
	FRAME SCREWS		
MIN. 2X4 WOOD FRAME OR BUCK (MIN. GR. 3 & G=0.55)	NO. 10 SMS OR WOOD SCREW	1 1/4"	3/4"
MIN. 16 GA. 33 KSI METAL STUD	NO. 10 GR. 5 SELF TAP/DRILL SCREW	FULL	1/2"
MIN. 1/8" THK A36 STEEL	NO. 10 GR. 5 SELF TAP/DRILL SCREW	FULL	1/2"
MIN. 1/8" THK 6063-T5 ALUM.	NO. 10 GR. 5 SELF TAP/DRILL SCREW	FULL	1/2"
MIN. C-90 CMU	(1) 1/4" CONCRETE SCREW	1 1/4"	2"
MIN. 2500 PSI CONCRETE	(1) 1/4" CONCRETE SCREW	1 1/2"	2"
	HINGE SCREWS		
MIN. 2X4 WOOD FRAME OR BUCK (MIN. GR. 3 & G=0.55)	NO. 12 SMS OR WOOD SCREW	1 1/4"	3/4"
MIN. 16 GA. 33 KSI METAL STUD	NO. 12 GR. 5 SELF TAP/DRILL SCREW	FULL	1/2"
MIN. 1/8" THK A36 STEEL	NO. 12 GR. 5 SELF TAP/DRILL SCREW	FULL	1/2"
MIN. 1/8" THK 6063-T5 ALUM.	NO. 12 GR. 5 SELF TAP/DRILL SCREW	FULL	1/2"
MIN. C-90 CMU	(1) 1/4" CONCRETE SCREW	1 1/4"	2"
MIN. 2500 PSI CONCRETE	(1) 1/4" CONCRETE SCREW	1 1/2"	2"
	STRIKE SCREWS		
MIN. 2X4 WOOD FRAME OR BUCK (MIN. GR. 3 & G=0.55)	NO. 10 SMS OR WOOD SCREW	1 1/4"	3/4"
MIN. 16 GA. 33 KSI METAL STUD	NO. 10 GR. 5 SELF TAP/DRILL SCREW	FULL	1/2"
MIN. 1/8" THK A36 STEEL	NO. 10 GR. 5 SELF TAP/DRILL SCREW	FULL	1/2"
MIN. 1/8" THK 6063-T5 ALUM.	NO. 10 GR. 5 SELF TAP/DRILL SCREW	FULL	1/2"
MIN. C-90 CMU	(1) 3/16" CONCRETE SCREW	1 1/4"	2"
MIN. 2500 PSI CONCRETE	(1) 3/16" CONCRETE SCREW	1 1/2"	2"
MOUNTING CLIP SCREWS			
MIN. 2X4 WOOD FRAME OR BUCK (MIN. GR. 3 & G=0.55)	NO. 8 SMS SCREW	1 3/8"	1/2"
MIN. 16 GA. 33 KSI METAL STUD	NO. 8 GR. 5 SELF TAP/DRILL SCREW	FULL	1/2"
MIN. 1/8" THK A36 STEEL	NO. 8 GR. 5 SELF TAP/DRILL SCREW	FULL	1/2"
MIN. 1/8" THK 6063-T5 ALUM.	NO. 8 GR. 5 SELF TAP/DRILL SCREW	FULL	1/2"
(1) CONCRETE SCREWS SHALL BE ELCO ULTRACONS (C.S.), ELCO CRETE-FLEX (S.S.), ITW RAMSET/RED HEAD TAPCONS (C.S. OR S.S.) OR HILTI KWIK-CON II (C.S OR S.S.).			

ALLOWABLE DESIGN PRESSURE (DOUBLE DOORS)

`		,		
MAXIMUM	MAXIMUM	DESIGN I	PRESSURE	
FRAME WIDTH (IN.)	FRAME HEIGHT (IN.)	POSITIVE (PSF)	NEGATIVE (PSF)	
	121.75	50.0	50.0	
98.75	110	55.3	55.3	
	98	62.1	62.1	
	121.75	53.1	53.1	
93	110	58.8	58.8	
	98	65.0	66.0	
87	121.75	56.8	56.8	
	110	62.8	62.8	
	98	65.0	70.5	
	121.75	61.0	61.0	
81	110	65.0	67.5	
	98	65.0	75.7	
74.25	121.75	65.0	66.5	
	110	65.0	73.6	
	98	65.0	80.0	
68	121.75	65.0	72.6	
	110	65.0	80.0	
62	121.75	65.0	79.6	

ALLOWABLE DESIGN PRESSURE (SINGLE DOORS)

1				
MAXIMUM	MAXIMUM	DESIGN PRESSURE		
FRAME WIDTH (IN.)	FRAME HEIGHT (IN.)	POSITIVE (PSF)	NEGATIVE (PSF)	
	121.75	50.0	50.0	
49.75	110	55.3	55.3	
	98	60.4	60.4	
	121.75	52.9	52.9	
47	110	58.6	58.6	
	98	63.2	63.9	
	121.75	56.5	56.5	
44	110	62.6	62.6	
	98	65.0	68.3	
,	121.75	60.7	60.7	
41	110	65.0	67.2	
Ì	98	65.0	73.3	
	121.75	65.0	66.3	
37.5	110	65.0	73.4	
	98	65.0	80.0	
35	121.75	65.0	71.1	
	110	65.0	78.7	
31	121.75	65.0	80.0	

ALLOWABLE DESIGN PRESSURE (VERTICAL MULLION)

AS CONTROLLED BY DOOR PRESSURE TABLES


`				Ш	5
MAXIMUM FRAME	MAXIMUM OVERALL	DESIGN	PRESSURE	DATE	01/09/15
WIDTH	HEIGHT	POSITIVE	NEGATIVE		Š
(IN.)	(IN.)	(PSF)	(PSF)	Β̈́	W.W.S.
	173.75	50.0	50.0		A1 UPDATE TO CURRENT STANDARDS
	162	53.6	53.6	읟	AND
	150	57.9	57.9	품	T ST
98.75	138	63.0	63.0	ES(REN
	126	65.0	68.9	z	SUR
	114	65.0	76.2	읈	ρ
	102	65.0	80.0	REVISION DESCRIPTION	ATE
	173.75	53.1	53.1		3
	162	56.9	56.9	Š	۲
93	150	61.5	61.5	╟┙	L
93	138	65.0	66.8		
	126	65.0	73.2		
	114	65.0	80.0		
	173.75	56.8	56.8		
	162	60.9	60.9		
87	150	65.0	65.7		
07	138	65.0	71.5		
	126	65.0	78.3		
	114	65.0	80.0		
	173.75	61.0	61.0	١	n
	162	65.0	65.4	٥	Ÿ
81	150	65.0	70.6	6	ひとしている
	138	65.0	76.7	1	
	126	65.0	80.0		5
	173.75	65.0	66.5	}	₹
74.25	162	65.0	71.3	5	Ξ
74.25	150	65.0	77.0	Ι,	_
	138	65.0	80.0	}	2
				}	COLOWING IMPACT
				ΙË	
				1 2	ر 5
			111	1	

ALLOWABLE DESIGN PRESSURE

(TRANSOM MULLION)

NOTE:

WITH MULLED UNITS, ALLOWABLE PRESSURE FOR THE OVERALL UNIT SHALL BE THE LESSER OF THE ALLOWABLE PRESSURE FOR THE INDIVIDUAL DOORS AND MULLION.

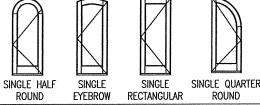

POSITIVE PRESSURE NOTE: WHEN THE ADA THRESHOLD IS USED,

THE UNITS ARE INSTALLED IN NON-HABITABLE AREAS WHERE THE

UNIT & THE AREA ARE DESIGNED TO ACCEPT WATER INFILTRATION

OR THE UNITS ARE INSTALLED AT LOCATIONS PROTECTED BY A

EQUAL TO OR MORE THAN 1.0 PER FBC.


CANOPY OR OVERHANG WHERE-BY THE OVERHANG(OH) RATIO IS

THE DOOR UNITS ARE NOT APPROVED FOR USE WHERE WATER

INFILTRATION RESISTANCE IS REQUIRED BY THE DOOR UNLESS



ROUND

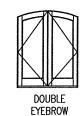



SHAPES CONSIDERED AS PART OF THIS APPROVAL

HINGE REQUIREMENTS			
MAXIMUM	# HINGES REQUIRED		
DOOR FRAME HEIGHT	PANEL WIDTH 36" & LESS	PANEL WIDTH GREATER THAN 36"	
82"	3	3	
98"	(1) 4	(1) 4	
122"	4	(1) 5	
/·/			

(1) ONE LESS HINGE IS REQUIRED WITH DOUBLE HALF ROUND & SINGLE QUARTER ROUND DOORS

SIF ONLY TO THE PRODU 100 S 1887

THESE DRAWINGS ARE APPLICABLE ONLY TO THE PRODUC SPECIFIED. THEY MAY NOT BE USED FOR THE ASSEMBLY AND/OR INSTALLATION OF ANY OTHER PRODUCT NOR MAY THEY BE USED FOR RATIONAL AND/OR LOCAL APPROVAL OF ANY PRODUCT NOT PRODUCED BY THE MANUFACTURER

SHEET NO. OF 11

CHECKED BY

W.W.S.

09/03/1

5 5 8

SIGNATURE DOOR INC. 401 JUNIATA STREET ALTOONA, PA 16602 814-949-2770

NSULTANTS

W. SCHAEFER ENGINEERING
CONSULTING, P.A. (CA 6809)
7480 150TH COURT NORTH
PALM BEACH GARDENS, FL. 33418


ଓ **≽∶&**


WOOD


FOOT


10

W.W.S.

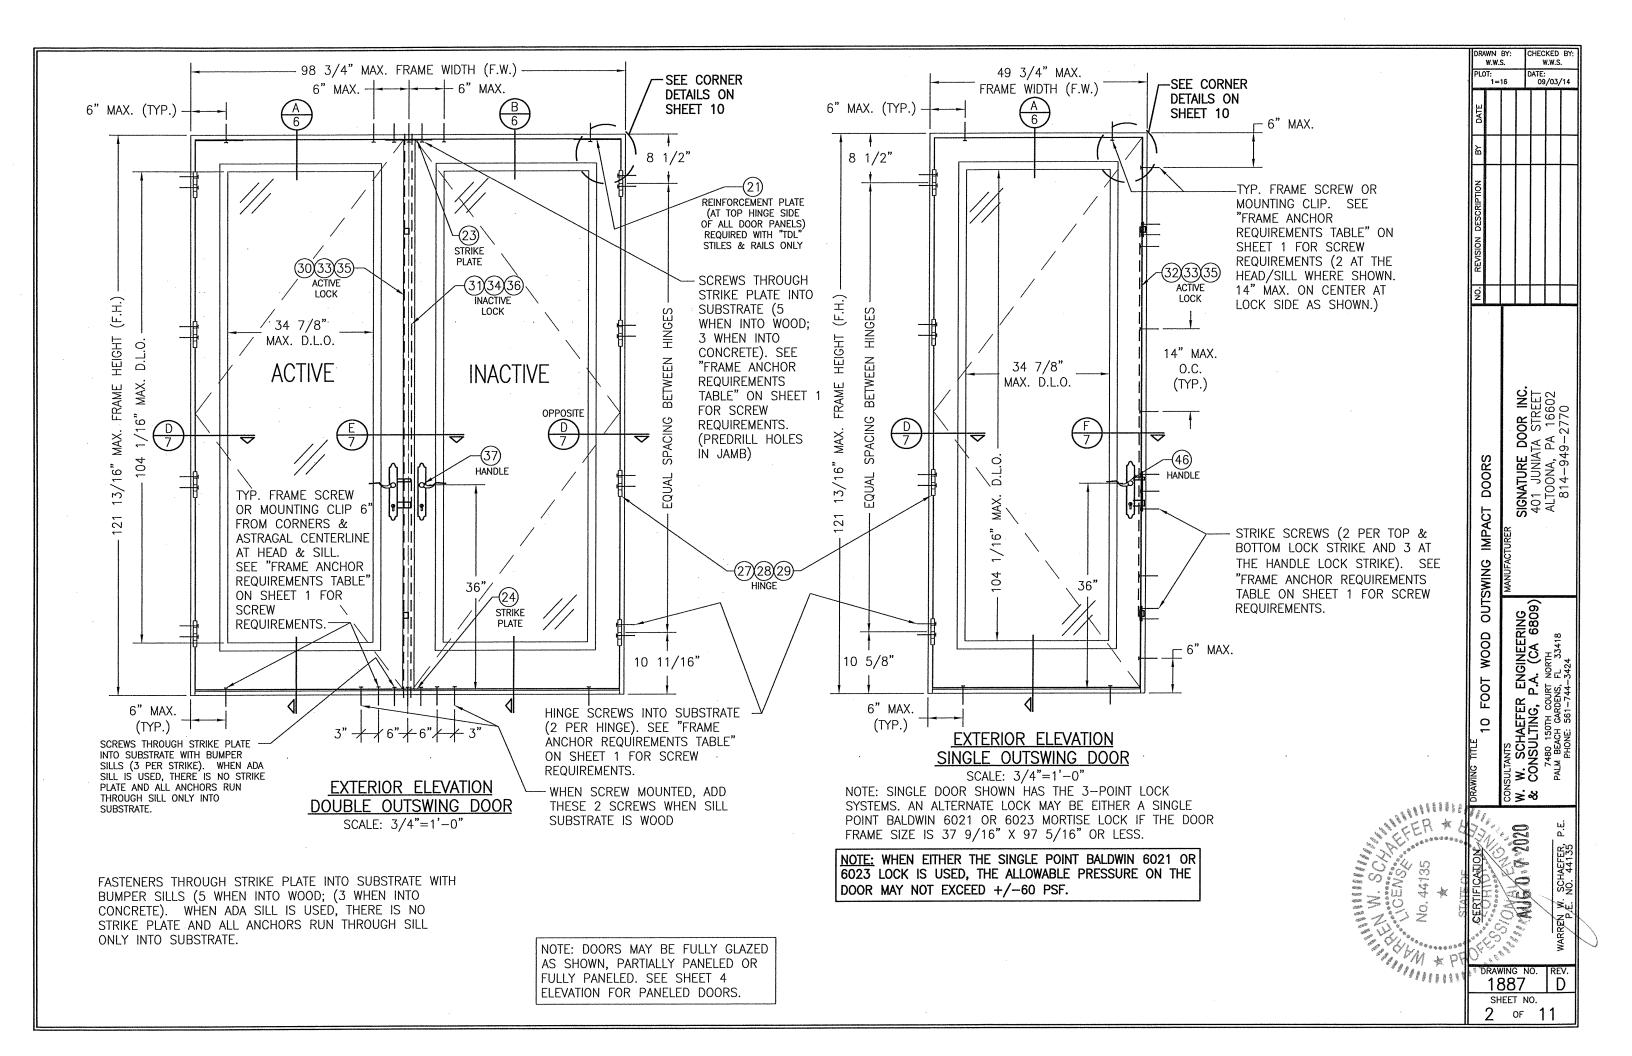


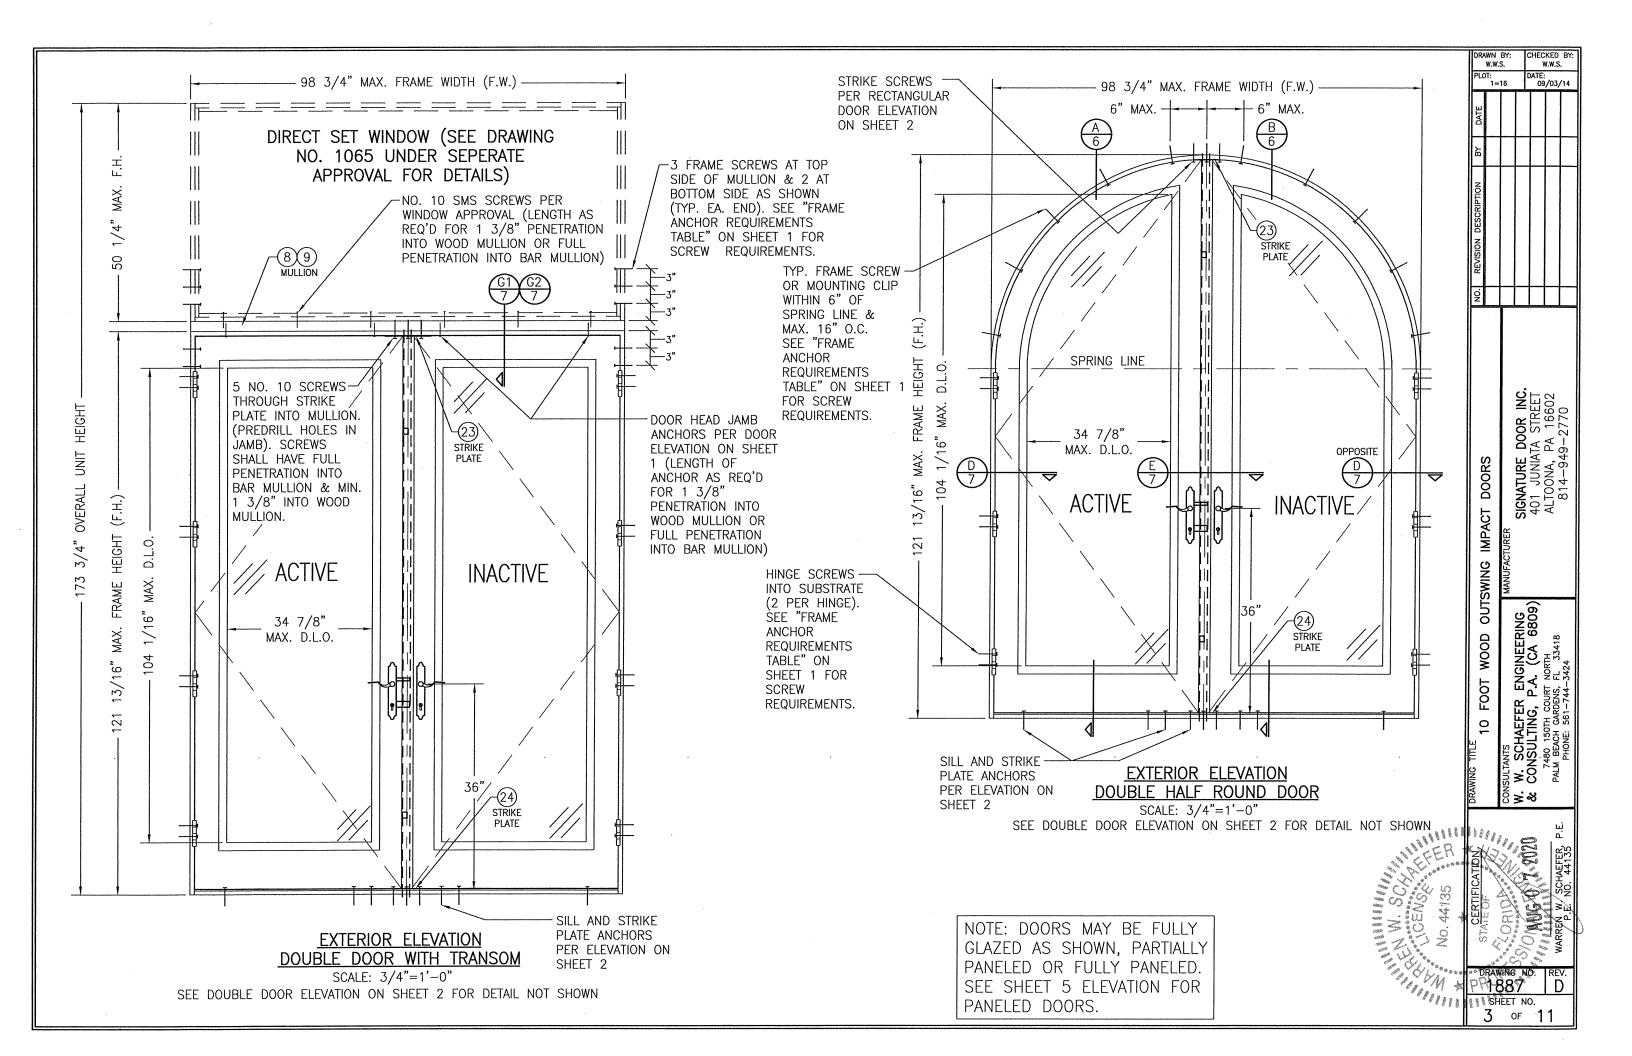

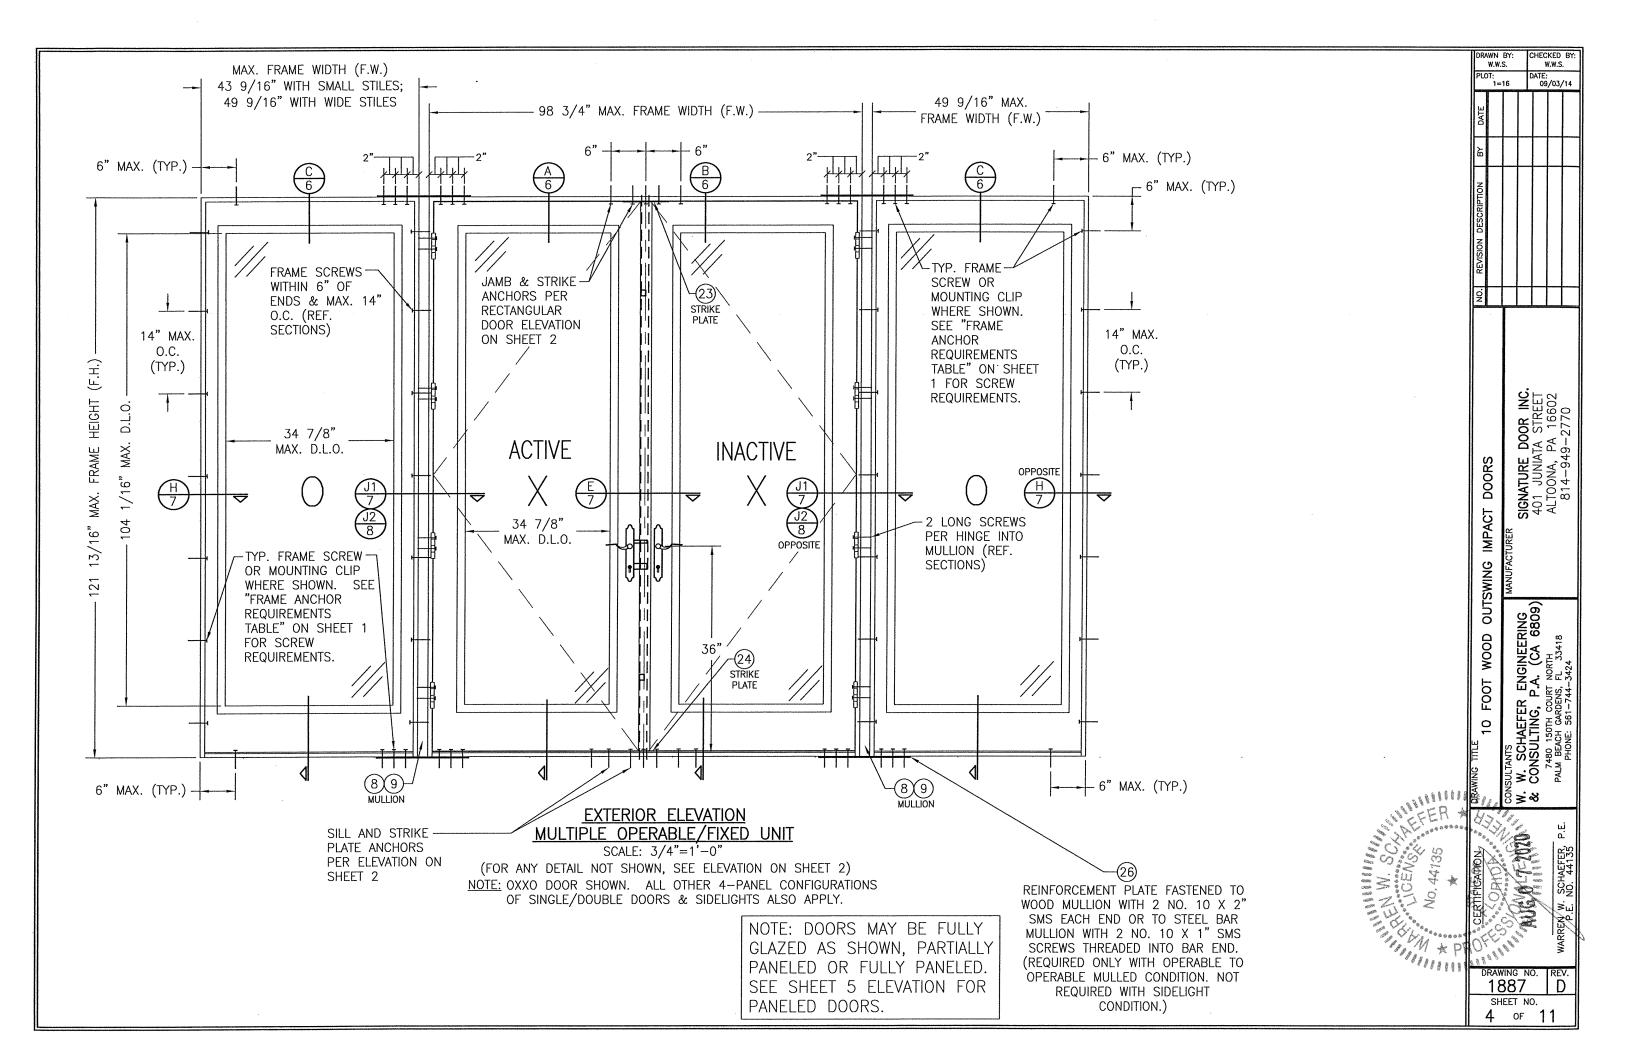


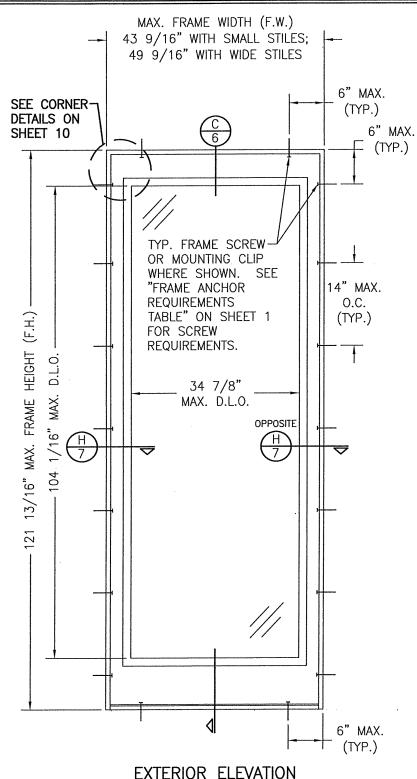


EXTERIOR ELEVATION
SINGLE FIXED PANEL
SCALE: 3/4"=1'-0"

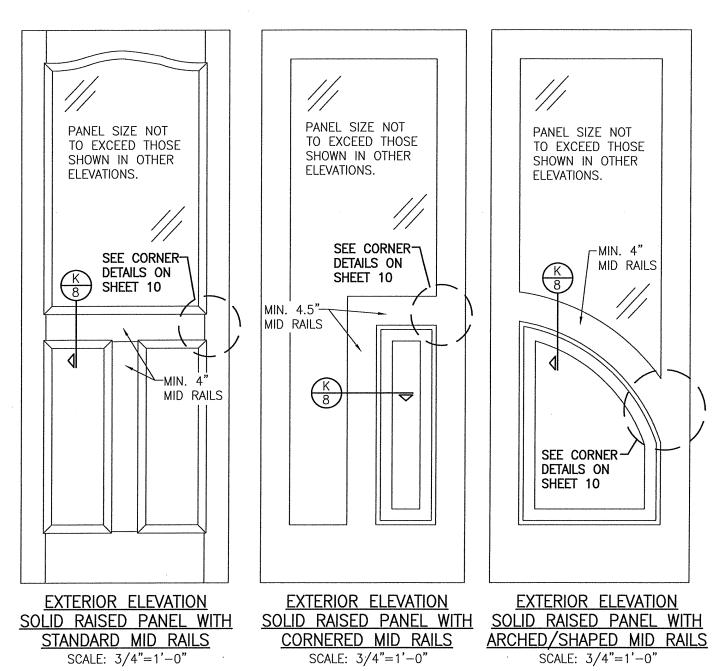



- 1) TOP & MID RAILS MAY BE OF ANY CONFIGURATION PROVIDING THE SMALLEST CROSS SECTION OF RAILS IS EQUAL TO OR LARGER THAN THAT DETAILED IN DRAWINGS.
- 2) MULTIPLE MID RAIL (BOTH HORIZONTAL & VERTICAL) MAY BE USED WITH THESE PANELS.
- 3) PARTIAL PANEL CONDITION IS SHOWN ABOVE. FULL PANEL DOORS AND OTHER PANEL CONFIGURATIONS ARE ALSO PART OF THIS APPROVAL AND ARE SIMILAR IN CONSTRUCTION TO THAT SHOWN ABOVE.
- 4) PANEL ONLY IS SHOWN. FOR INSTALLATION INTO FRAME, SEE OTHER ELEVATIONS.

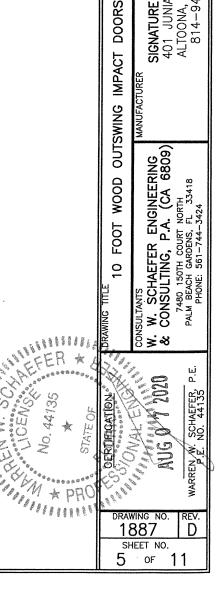


ATE: 09/03/14

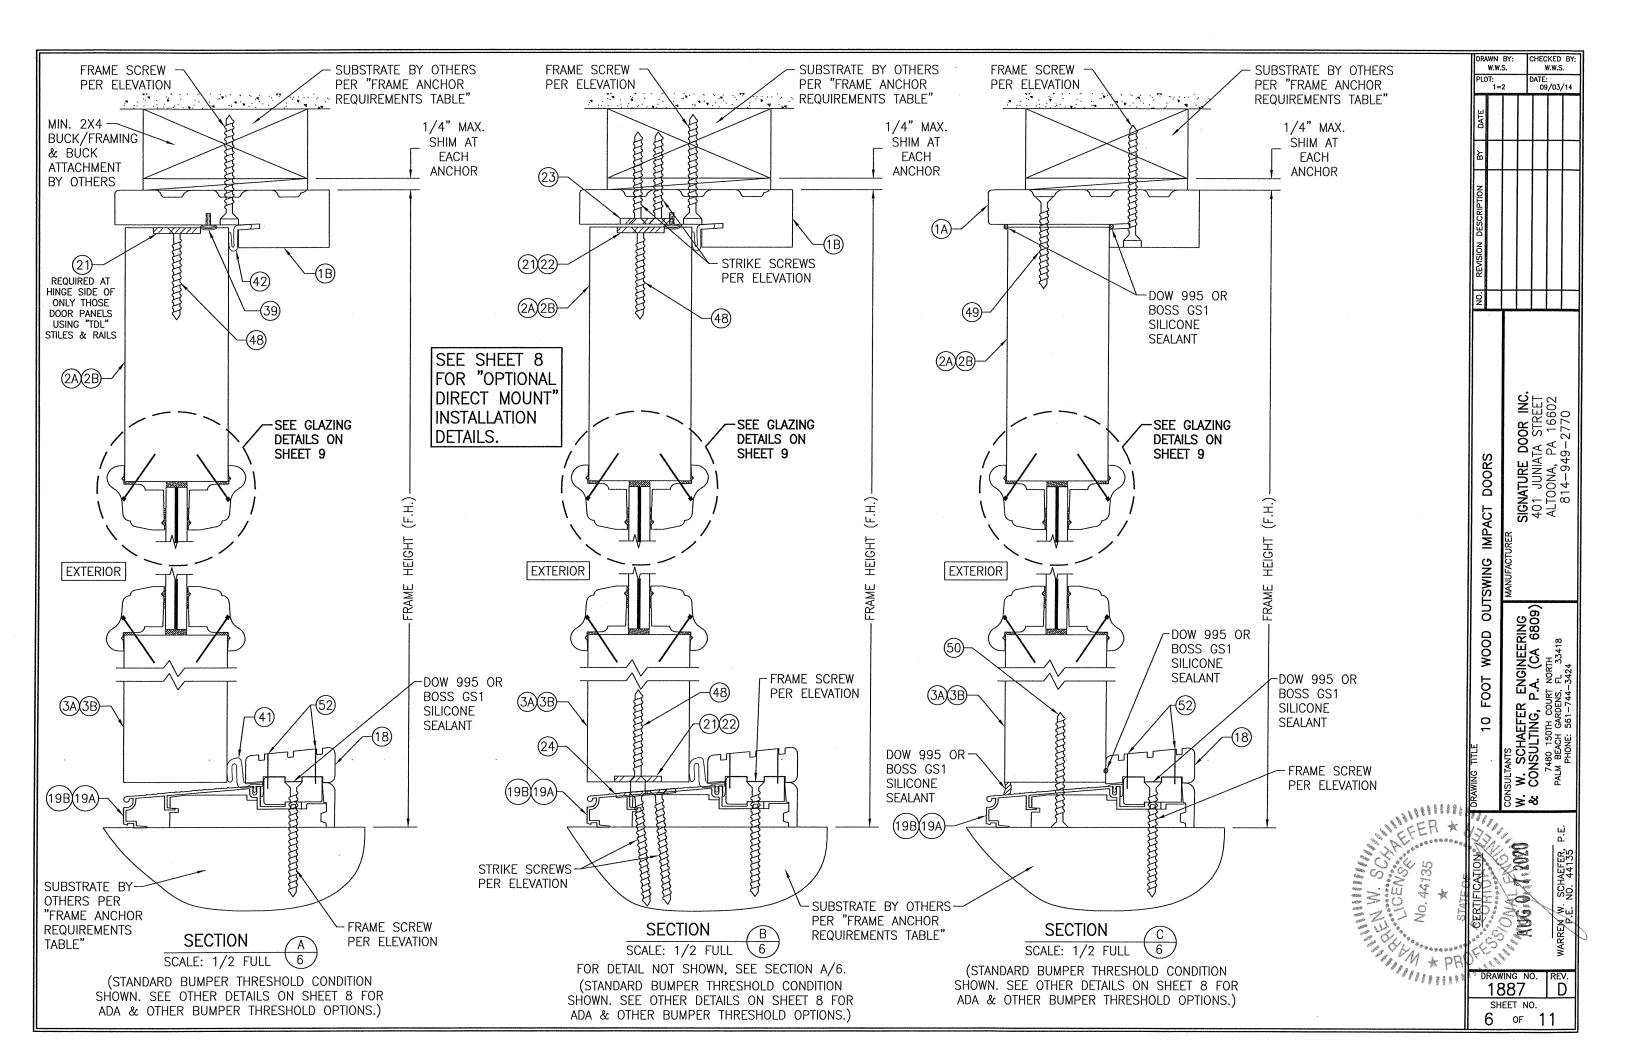

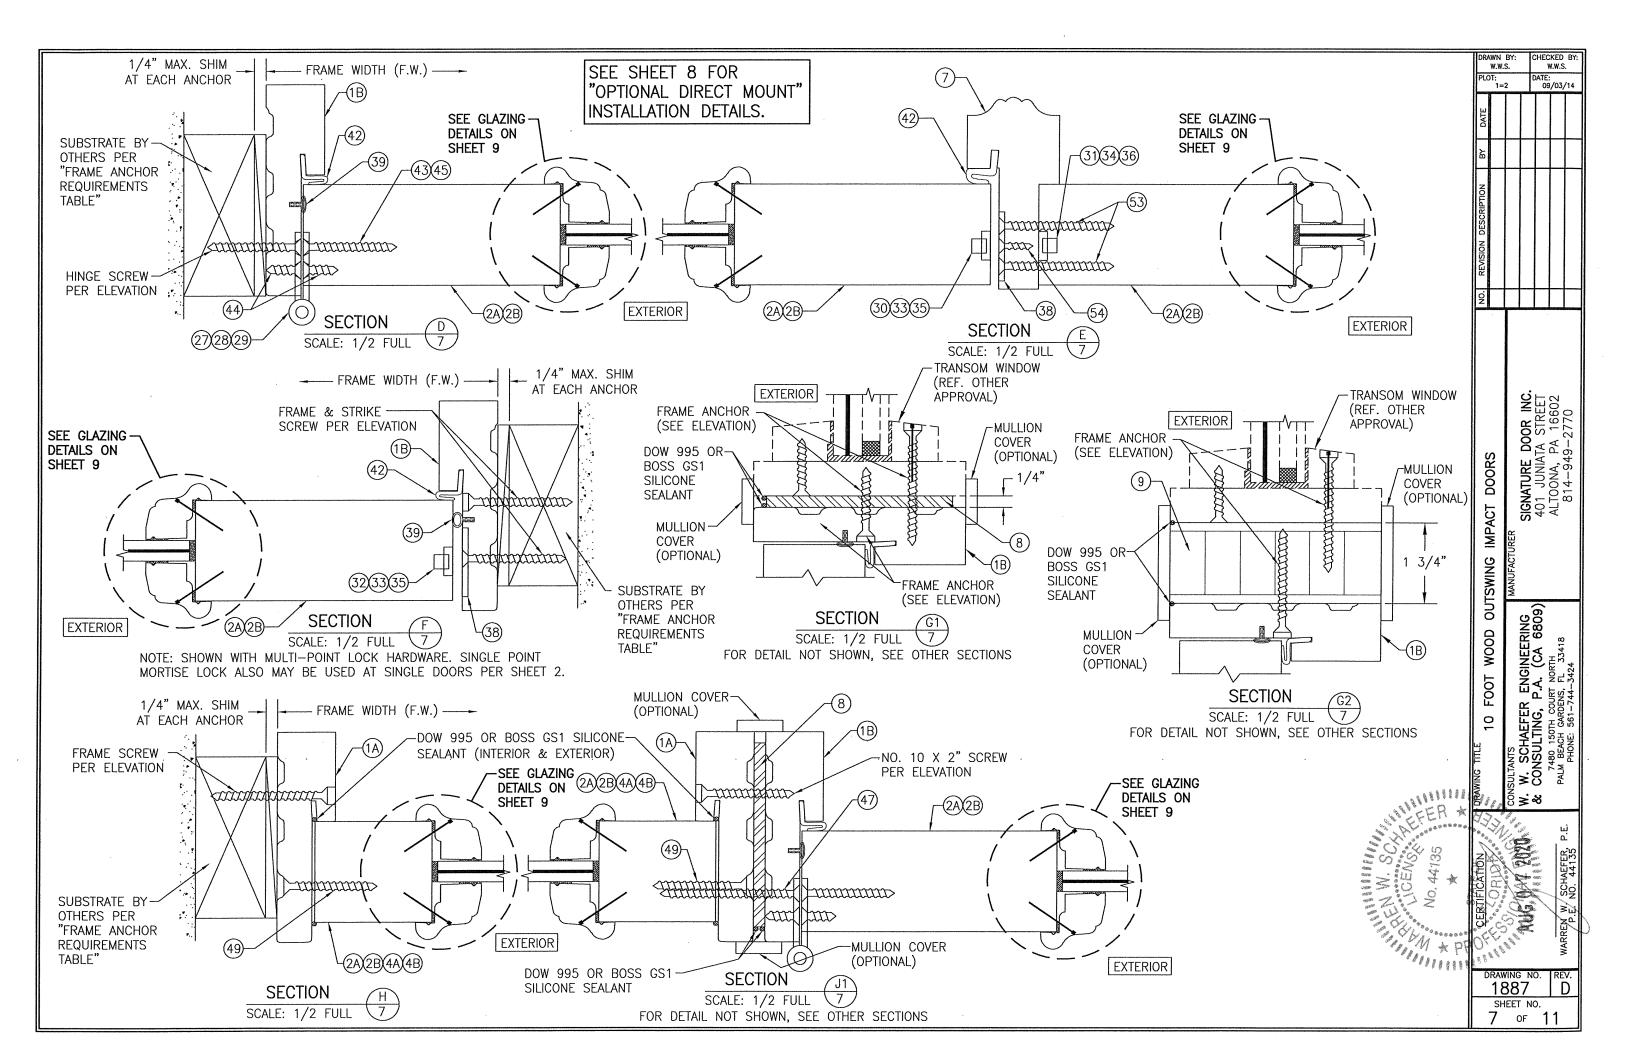


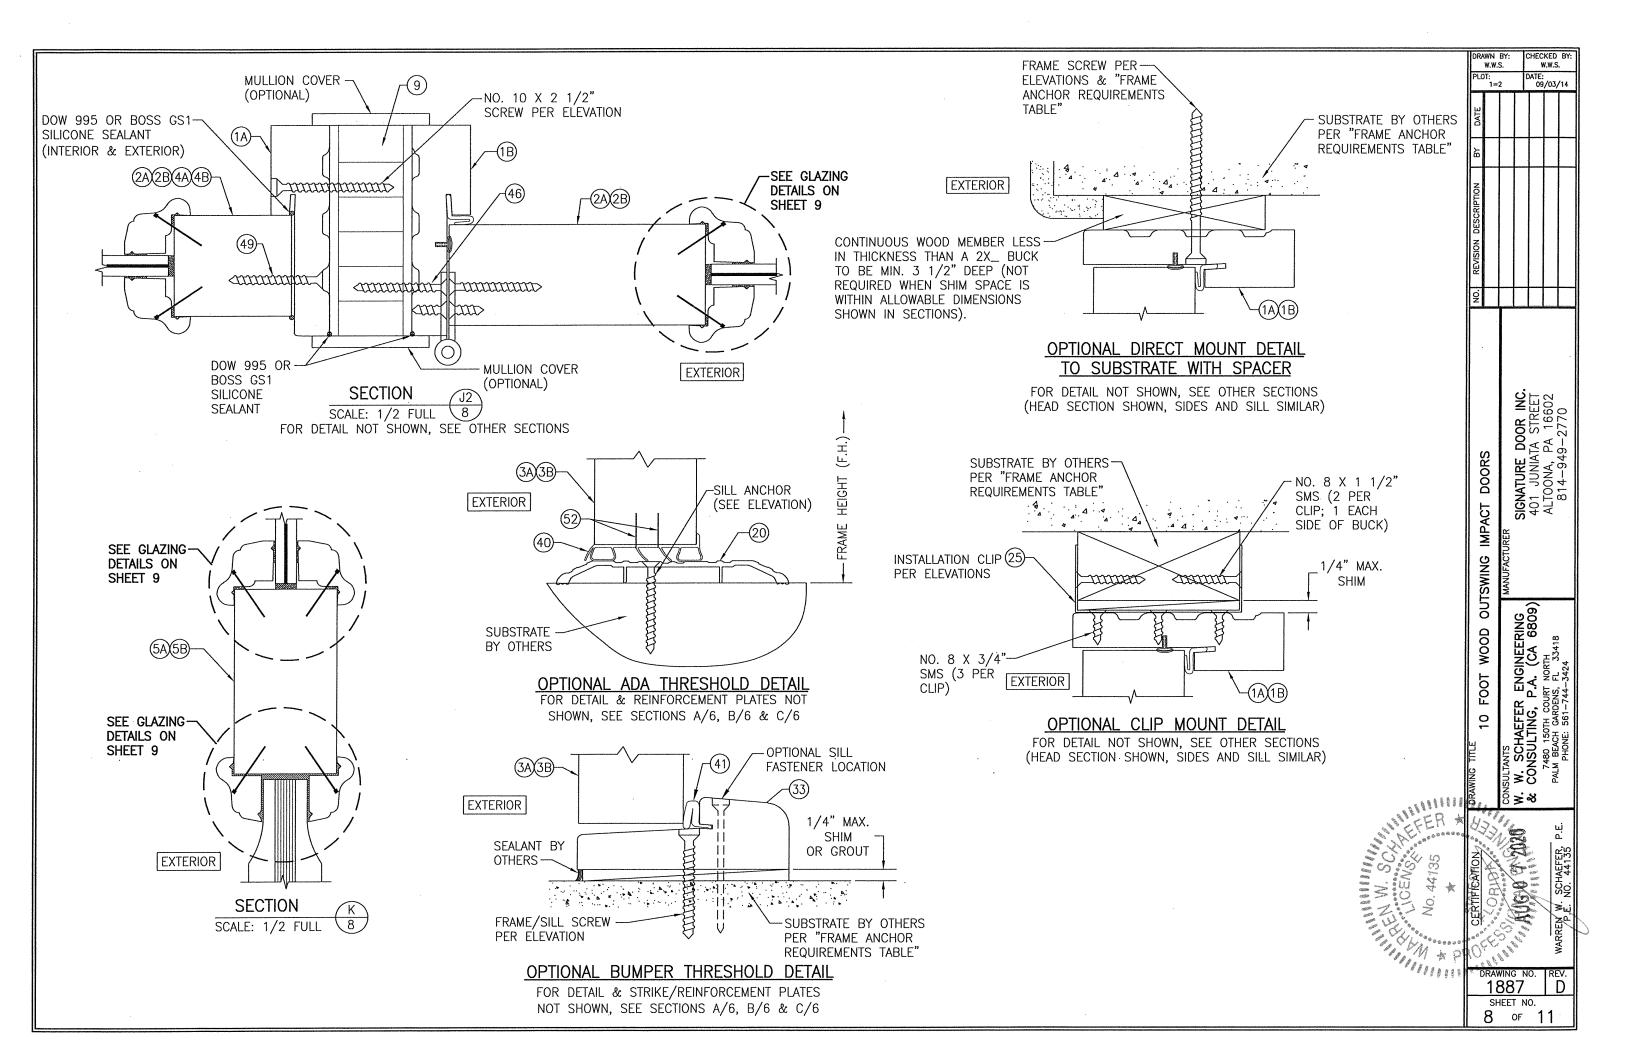

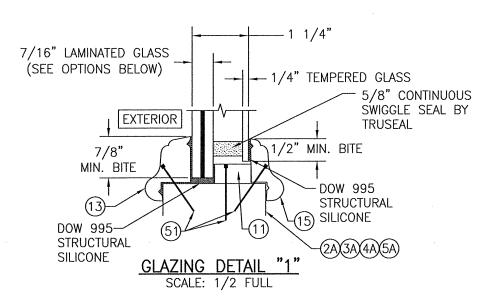


GLASS OPTION: 1) 7/16" THICK GLASSLAM SAFETY PLUS II LAMINATED OUTER GLASS (3/16" AN/0.10" POLYURETHANE POLYMER/3/16" AN); 3/16" TEMPERED SINGLE PANE INNER GLASS

> 2) 7/16" THICK LAMINATED OUTER GLASS (3/16" AN/0.075" EASTMAN CHEM. CO. SAFLEX CP/3/16" AN); 3/16" TEMPERED SINGLE PANE INNER GLASS

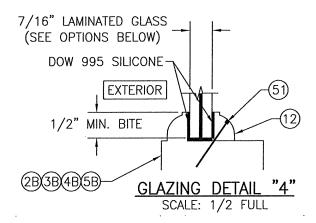


GLASS OPTION: 1) 7/16" THICK GLASSLAM SAFETY PLUS II LAMINATED GLASS (3/16" AN/0.10" POLYURETHANE POLYMÉR/3/16" AN)

> 2) 7/16" THICK LAMINATED GLASS (3/16" AN/0.075" EASTMAN CHEM. CO. SAFLEX CP/3/16" AN)

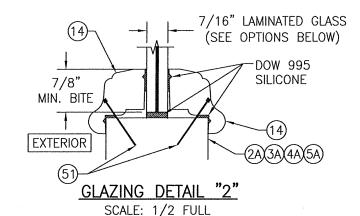


GLASS OPTION: 1) 7/16" THICK GLASSLAM SAFETY PLUS II LAMINATED GLASS (3/16" AN/0.10" POLYURETHANE POLYMÉR/3/16" AN)


> 2) 7/16" THICK LAMINATED GLASS (3/16" AN/0.075" EASTMAN CHEM. CO.SAFLEX CP/3/16" AN)

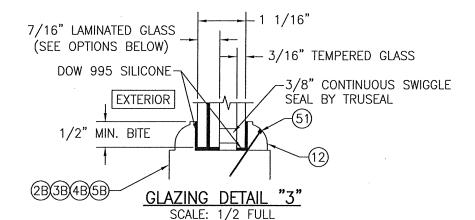

GLASS OPTION: 1) 7/16" THICK GLASSLAM SAFETY PLUS II LÁMINATED OUTER GLASS (3/16" AN/0.10" POLYURETHANE POLYMER/3/16" AN); 3/16" TEMPERED SINGLE PANE INNER GLASS

> 2) 7/16" THICK LAMINATED OUTER GLASS (3/16" AN/0.075" EASTMAN CHEM. CO. SAFLEX CP/3/16" AN); 3/16" TEMPERED SINGLE PANE INNER GLASS

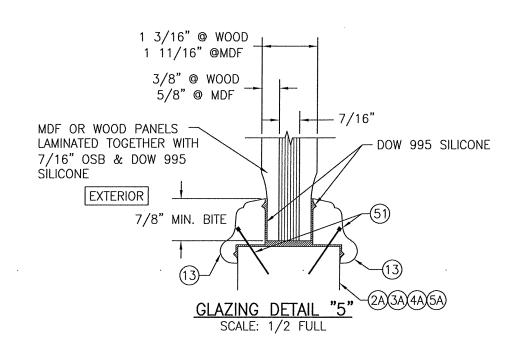

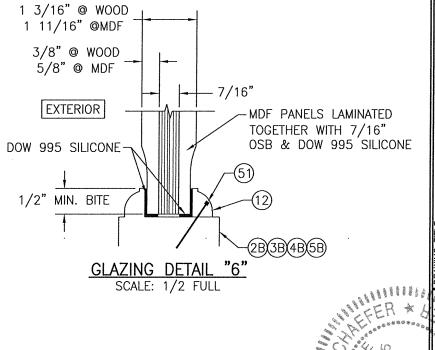

1000 1887

D SHEET NO. 9 OF 11

OATE: 09/03/14

SIGNATURE DOOR INC. 401 JUNIATA STREET ALTOONA, PA 16602 814-949-2770

W. SCHAEFER ENGINEERING CONSULTING, P.A. (CA 6809)

ઇ્ટ ≯ જ

OUTSWING IMPACT DOORS

FOOT WOOD

9

