

Tel +1 407 304 5560 Fax +1 407 304 5561 intertek.com/building



January 10, 2024

Mr. Thomas Campbell Florida Department of Business and Professional Regulation Codes & Standards Office 2601 Blair Stone Road, Building C Tallahassee, FL 32399-0772

RE: **Manufacturer: South Country Sheds** 

Agency Plan Number: R-21252 (FL) Barn Roof Shed

Dear Mr. Campbell,

Architectural Testing Inc., an Intertek company ("Intertek-ATI"), part of Intertek<sup>1</sup> Building Science Solutions, in accordance with the requirements of the Florida Department of Business and Professional Regulations, the above-referenced documents have been reviewed for compliance with:

Florida Building Code, 8th Edition with Latest Supplements 2023

2020 **National Electrical Code (NFPA-70-20)** 

This approval covers the factory-built structure only. Any alterations to the factory-built structure on site would avoid approval. This plan is subject to the following:

- This plan is Not Approved for High-Velocity Hurricane Zone (i.e., Broward and Miami/Dade
- Signed and sealed plans are on file with Intertek-ATI
- Chapter 633 Plan Review and Inspection shall be conducted by the local fire and safety
- Items installed on-site are subject to review and approval by the local authority having jurisdiction.
- This review includes products for compliance with 553.8425 or FAC Chapter 61G20-3

If you have any questions or require our assistance, please do not hesitate to contact us.


Respectfully submitted,

Ryan Knowles


Ryan Knowles Senior Manager **Building Science Solutions** 





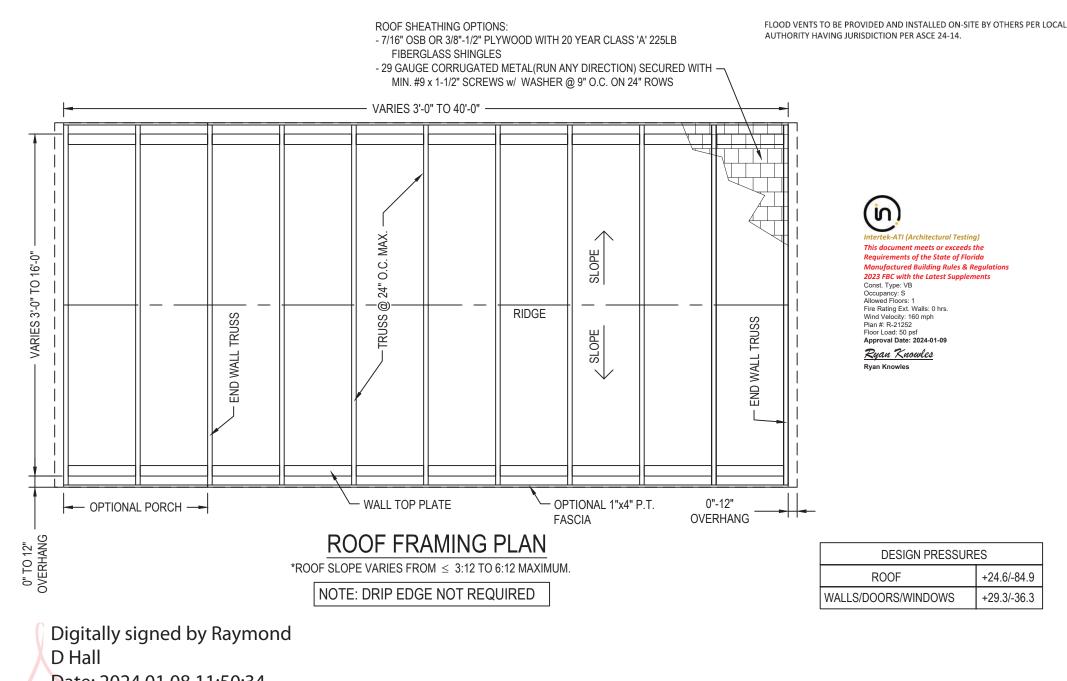

Raymond D Hall

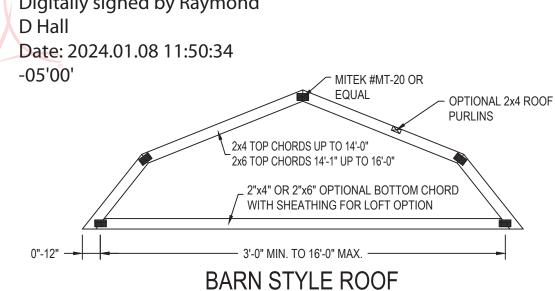



Bay Engineering, LLC 4177 Coporate CT Palm Harbor, FL 34683 FL Lic. # 53759 FL COA# 36094



CODE INFORMATION		
CODE VERSION	2023 FLORIDA BUILDING CODE 8TH EDITION, ASCE-22, 2020 NEC	
MANUFACTURER	SOUTH COUNTRY SHEDS	
BUILDING TYPE	MANUFACTURED BUILDING RESIDENTIAL LAWN STORAGE	
CONSTRUCTION TYPE	V-B	
FIRE PROTECTION	NONE	
FIRE SUPPRESSION SYSTEM	NONE	
OCCUPANCY	STORAGE	
ALLOWABLE NUMBER OF STORIES	1	
BASIC WIND SPEED	Vult-160 MPH	
EXPOSURE	D	
ENCLOSURE	ENCLOSED	
INTERNAL PRESSURE COEFFICIENT	+/- 0.18	
IMPORTANCE FACTOR	1.15	
ROOF DEAD LOAD	10 PSF	
ROOF LIVE LOAD	20 PSF OR 300LB POINT LOAD	
FLOOR DEAD LOAD	10 PSF	
FLOOR LIVE LOAD	50 PSF	
"R" RATING OF WALLS, FLOOR, ROOF	N/A	
MODULES PER BUILDING	1	
HURRICANE PROTECTION USEAGE	NO	
HURRICANE SHELTER USAGE	NO	
SQUARE FOOTAGE	719 SQ. FT. OR LESS	

**REVISIOINS** DESCRIPTION

	DRAWN BY:	RDH	
	DATE:	12/5/2023	
	SCALE:	3/8"= 1'-0"	
	MODEL#:	SCS-B-160D	

DATE BY

# PLAN

ER

MASTE

Щ

STYLI

BARN

LAYOUT/


00F


 $\check{\simeq}$ 

- FOUNDATION PLANS ARE NOT PART OF THIS PLAN SET AND ARE GOVERNED BY LOCAL JURISDICTION. THIS BUILDING IS EXEMPT FROM THE FBC ENERGY CONSERVATION CODE PER SECTION 1015.22.
- REFER TO TIE-DOWN DETAILS FOR PROPER
- INSTALLATION REQUIREMENTS TO MEET CODE. ALL STUDS, RAFTERS, TRUSSES, ETC. ARE 2x4 SPF#2, EXCEPT AS NOTED.
- STRUCTURES OVER 400 SQ. FT. WILL HAVE AN 80" MINIMUM DOOR.
- GUTTERS TO BE INSTALLED ON-SITE BY OTHERS THRU LOCAL CODES.
- ALL WINDOWS AND DOORS TO MEET THE MINIMUM SPECIFICATIONS AS PER FLORIDA BUILDING CODE.
- IN ACCORDANCE WITH FBC 1609.1.2, STORAGE SHEDS ARE NOT DESIGNED FOR HUMAN HABITATION WITH A FLOOR AREA OF LESS THAN 720 SQUARE FEET ARE NOT REQUIRED TO COMPLY WITH THE MANDATORY WINDBORNE DEBRIS IMPACT STANDARDS OF THE 2023 FBC.
- IN ACCORDANCE WITH FBD 1008.1.1; BUILDINGS THAT ARE 400 SQUARE FEET OR LESS THAT ARE INTENDED FOR USE IN CONJUNCTION WITH ONE AND TWO FAMILY RESIDENCES ARE NOT SUBJECT TO THE DOOR HEIGHT AND WIDTH REQUIREMENTS OF THE FBC 2023.
- IN ACCORDANCE WITH FLORIDA STATE STATUTE 553.80(1)d, LAWN STORAGE BUILDINGS AND STORAGE SHEDS BEARING THE INSIGNIA OF APPROVAL OF THE DEPARTMENT ARE NOT SUBJECT TO ∰553.842 (FLORIDA PRODUCT APPROVALS ARE NOT REQUIRED FOR WINDOWS, DOORS, OR OTHER COMPONENTS)

SHEET:

FBPR-1 OF 8

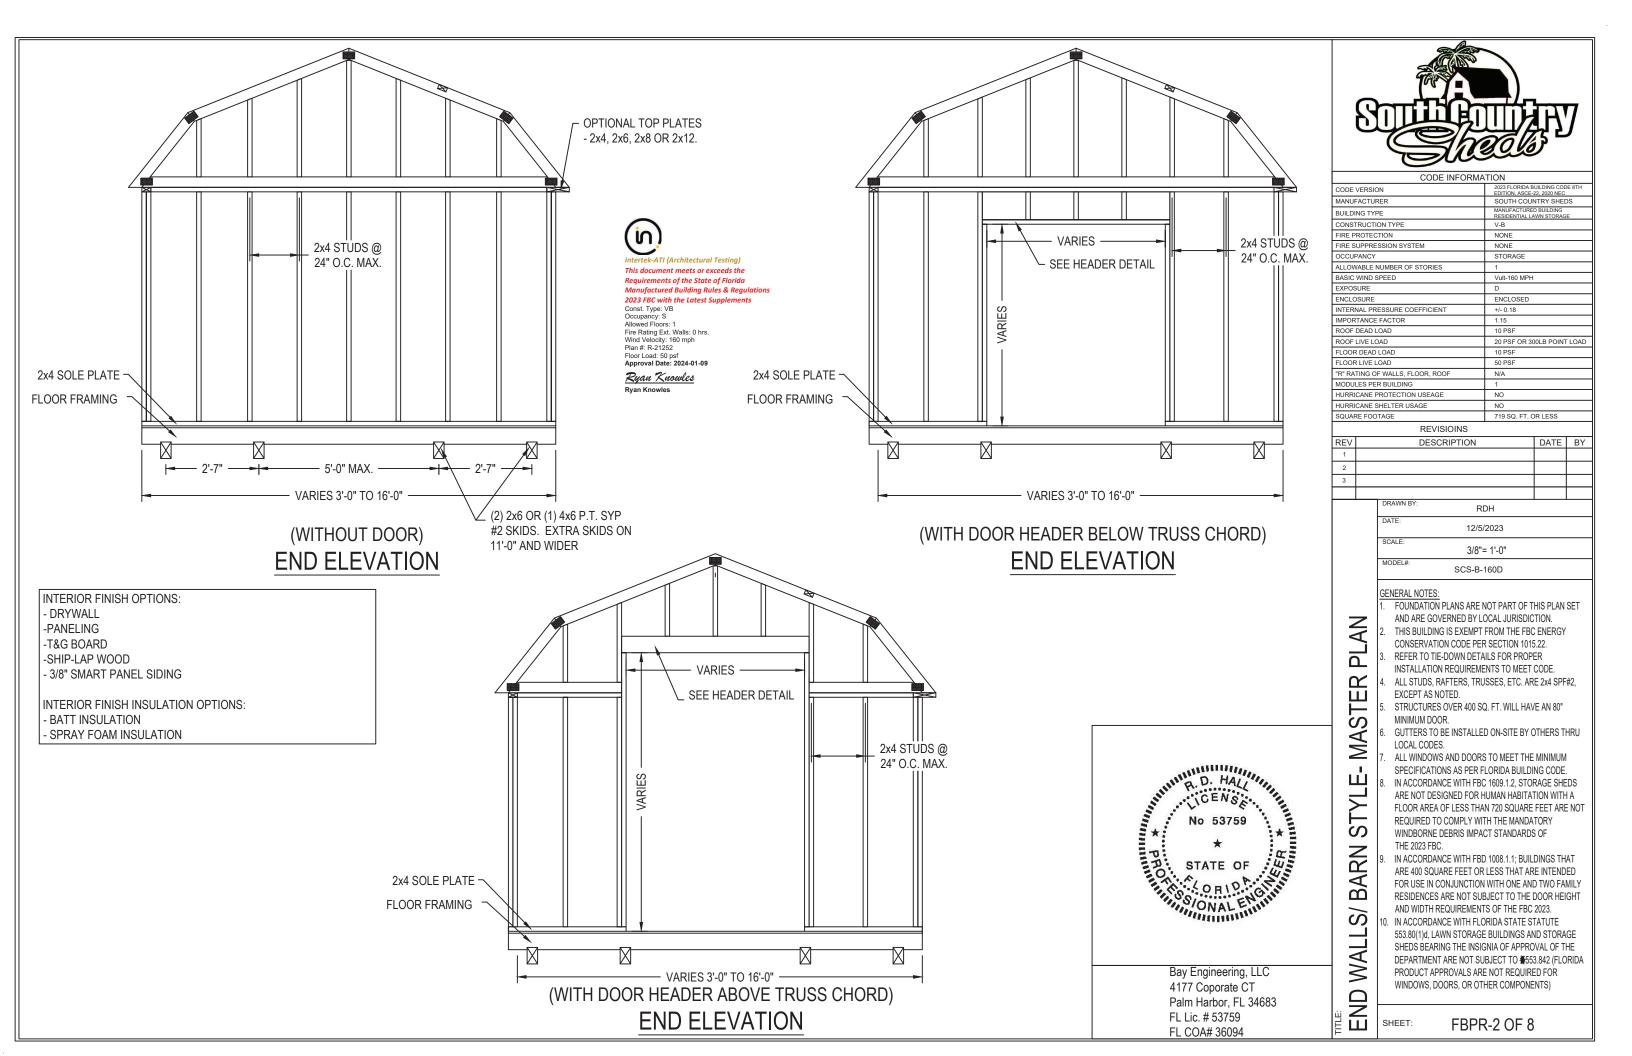

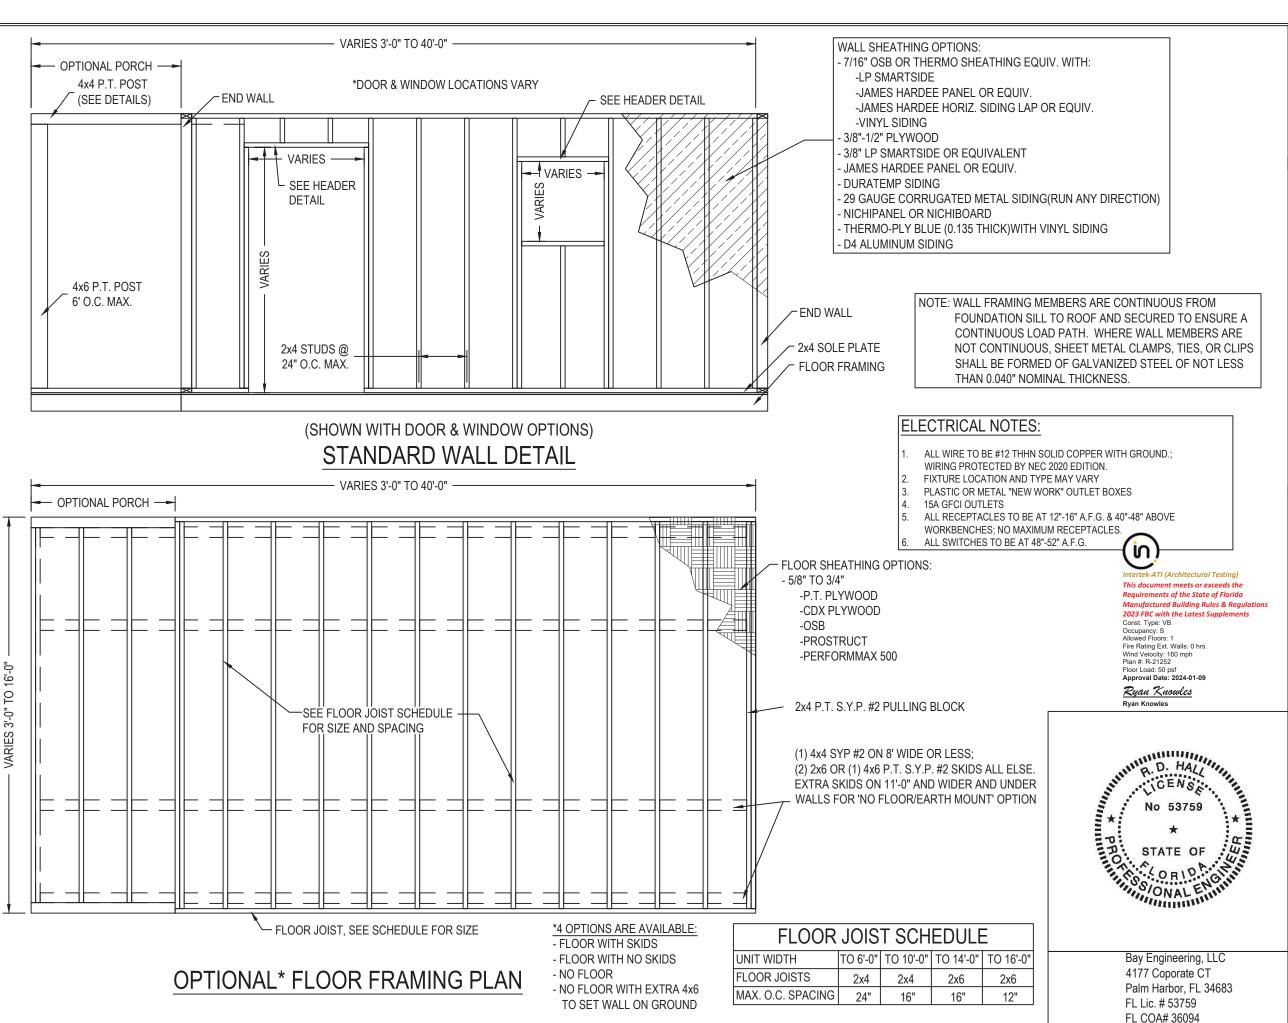

STITLE PLANT OF THE PARTY OF TH

CODE INFORMATION		
CODE VERSION	2023 FLORIDA BUILDING CODE 8TH EDITION, ASCE-22, 2020 NEC	
MANUFACTURER	SOUTH COUNTRY SHEDS	
BUILDING TYPE	MANUFACTURED BUILDING RESIDENTIAL LAWN STORAGE	
CONSTRUCTION TYPE	V-B	
FIRE PROTECTION	NONE	
FIRE SUPPRESSION SYSTEM	NONE	
OCCUPANCY	STORAGE	
ALLOWABLE NUMBER OF STORIES	1	
BASIC WIND SPEED	Vult-160 MPH	
EXPOSURE	D	
ENCLOSURE	ENCLOSED	
INTERNAL PRESSURE COEFFICIENT	+/- 0.18	
IMPORTANCE FACTOR	1.15	
ROOF DEAD LOAD	10 PSF	
ROOF LIVE LOAD	20 PSF OR 300LB POINT LOAD	
FLOOR DEAD LOAD	10 PSF	
FLOOR LIVE LOAD	50 PSF	
"R" RATING OF WALLS, FLOOR, ROOF	N/A	
MODULES PER BUILDING	1	
HURRICANE PROTECTION USEAGE	NO	
HURRICANE SHELTER USAGE	NO	
SQUARE FOOTAGE	719 SQ. FT. OR LESS	

2					
3					
		DRAWN BY:	RDH		
		DATE:	12/5/2023		
		SCALE:	3/8"= 1'-0"		

DATE BY

REVISIOINS

DESCRIPTION

### GENERAL NOTES

LAYOUT

OOR

 $\mathbf{H}$ 

**OPTIONAL** 

AYOUT/

'ALL

 FOUNDATION PLANS ARE NOT PART OF THIS PLAN SET AND ARE GOVERNED BY LOCAL JURISDICTION.
 THIS BUILDING IS EXEMPT FROM THE FBC ENERGY

SCS-B-160D


- CONSERVATION CODE PER SECTION 1015.22.
  3. REFER TO TIE-DOWN DETAILS FOR PROPER
- 3. REFER TO TIE-DOWN DETAILS FOR PROPER INSTALLATION REQUIREMENTS TO MEET CODE.
- ALL STUDS, RAFTERS, TRUSSES, ETC. ARE 2x4 SPF#2, EXCEPT AS NOTED.
- STRUCTURES OVER 400 SQ. FT. WILL HAVE AN 80" MINIMUM DOOR.
- GUTTERS TO BE INSTALLED ON-SITE BY OTHERS THRU LOCAL CODES.
- ALL WINDOWS AND DOORS TO MEET THE MINIMUM SPECIFICATIONS AS PER FLORIDA BUILDING CODE.
- IN ACCORDANCE WITH FBC 1609.1.2, STORAGE SHEDS ARE NOT DESIGNED FOR HUMAN HABITATION WITH A FLOOR AREA OF LESS THAN 720 SQUARE FEET ARE NOT REQUIRED TO COMPLY WITH THE MANDATORY WINDBORNE DEBRIS IMPACT STANDARDS OF THE 2023 FBC.
- IN ACCORDANCE WITH FBD 1008.1.1; BUILDINGS THAT ARE 400 SQUARE FEET OR LESS THAT ARE INTENDED FOR USE IN CONJUNCTION WITH ONE AND TWO FAMILY RESIDENCES ARE NOT SUBJECT TO THE DOOR HEIGHT AND WIDTH REQUIREMENTS OF THE FBC 2023.
- 10. IN ACCORDANCE WITH FLORIDA STATE STATUTE
  553.80(1)d, LAWN STORAGE BUILDINGS AND STORAGE
  SHEDS BEARING THE INSIGNIA OF APPROVAL OF THE
  DEPARTMENT ARE NOT SUBJECT TO 書53.842 (FLORIDA
  PRODUCT APPROVALS ARE NOT REQUIRED FOR
  WINDOWS, DOORS, OR OTHER COMPONENTS)

SHEET: FRI


FBPR-3 OF 8

### HEADER DETAILS AND EQUIVALENT SIZES


\*NOTES SEE FASTENER SCHEDULE FOR HARDWARE REQUIREMENTS. SEE HEADER SCHEDULE FOR ADDITIONAL INFORMATION.

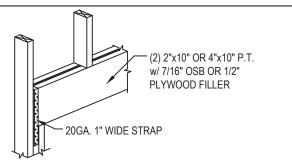


(2) 2"x10" OR 4"x10"

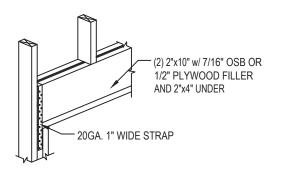

(2) 2"x10"w/2"x4"

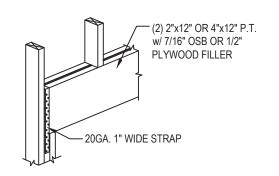

(2) 2"x12" OR 4"x12"

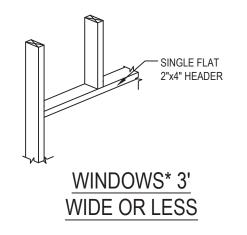

FLOOD VENTS TO BE PROVIDED AND INSTALLED ON-SITE BY OTHERS PER LOCAL AUTHORITY HAVING JURISDICTION PER ASCE 24-14. **EXTERIOR** SHEATHING 8 1/4" x 16 1/4" ROUGH OPENING CUT BETWEEN WALL STUDS. VENT IS SECURED TO SHEATHING AS PER MANUFACTURERS INSTRUCTIONS HYDROVENT DETAIL


(OPTIONAL)

END WALL HEADER SCHEDULE 160D (e,f)			
0175 (-1)	(d) MAX. SPAN NJ (b)		FASTENERS w/o
SIZE (a)			STRAP;EACH END (c)
(1) 2x4 SPF#2	3'-0"	1	(3) 3" x 0.131" NAILS
(2) 2x4 SPF#2	6'-3"	1	(6) 3" x 0.131" NAILS
(2) 2x6 SPF#2 10'-0" 1 (6) 3" x 0.131" NAILS			
	SIZE (d) (1) 2x4 SPF#2 (2) 2x4 SPF#2	SIZE (d) MAX. SPAN  (1) 2x4 SPF#2 3'-0"  (2) 2x4 SPF#2 6'-3"	SIZE (d) MAX. SPAN NJ (b)  (1) 2x4 SPF#2 3'-0" 1  (2) 2x4 SPF#2 6'-3" 1

- a. TABULATED VALUES ARE FOR No. 2 GRADE SPRUCE-PINE-FIR LUMBER
- b. NJ- NUMBER OF JACK STUDS REQUIRED TO SUPPORT EACH END.
- INCLUDES 7/16" OSB OR 1/2" PLYWOOD FILLER
- (FILLERS CAN BE BETWEEN BOARDS OR ON INSIDE OF STRUCTURE)
- d. SEE HEADER DETAILS FOR ALTERNATE LAYOUTS, i.e. (2) 2x4 OR 4" x 4" P.T.
- e. THIS TABLE IS ONLY FOR HEADERS BELOW THE END WALL TRUSS. USE SIDEWALL HEADER SCHEDULE FOR HEADERS THAT BREAK BOTTOM CHORD OF END WALL TRUSS

SIDE WALL HEADER SCHEDULE 160D (e)			
SIZE (d)	BUILDING WIDTH UP TO 16' WIDE		FASTENERS w/o
( )	MAX. SPAN	NJ (b)	STRAP;EACH END (c)
(1) 2x4 SPF#2 (f)	3'-0"	0	(3) 3" x 0.131" NAILS
(2) 2x4 SPF#2	6'-3"	1	(6) 3" x 0.131" NAILS
(2) 2x6 SPF#2	9'-0"	1	(6) 3" x 0.131" NAILS
(2) 2x8 SPF#2	9'-6"	2	(8) 3" x 0.131" NAILS
(2) 2x10 SPF#2	10'-6"	2	
(2) 2x12 SPF#2	11'-6"	2	

- a. TABULATED VALUES ARE FOR No. 2 GRADE SPRUCE-PINE-FIR LUMBER
- . NJ- NUMBER OF JACK STUDS REQUIRED TO SUPPORT EACH END.
- INCLUDES 7/16" OSB OR 1/2" PLYWOOD FILLER (FILLERS CAN BE BETWEEN BOARDS OR ON INSIDE OF STRUCTURE).
- SEE HEADER DETAILS FOR ALTERNATE LAYOUTS, i.e. (2) 2x4 OR 4" x 4" P.T.
- WINDOW HEADER FOR WINDOW OPENINGS THAT HAVE MORE THAN 50% COMBINED STUD WALL ABOVE AND BELOW. OTHERWISE USE DOOR HEADER SCHEDULE.
- THE HEADER CAN BE ATTACHED TO THE TOP PLATE AND THUSLY HAVE THE COMBINED STRENGTH EQUIVALENT AND USE THE MAXIMUM SPAN STATE. SEE HEADER DETAILS FOR EQUIVALENT SIZES.

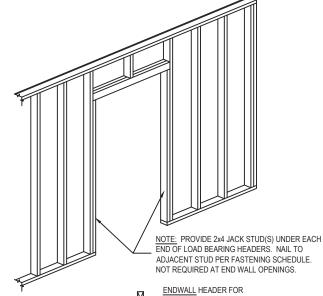

2x4 (TYP) (FASTEN PER FASTENING SCHEDULE) - ENDWALL HEADER FOR OPENINGS UP TO 6'-3" (75") SIDEWALL HEADER FOR OPENINGS UP TO 4'-0"

(2) 2x4 w/ 7/16" OSB FLITCH PLATE (FASTEN PER FASTENING SCHEDULE)

ENDWALL HEADER FOR **OPENINGS UP TO 6'-3" (75")** SIDEWALL HEADER FOR **OPENINGS UP TO 6'-3" (75")** 

(2) 2x6 w/ 7/16" OSB FLITCH PLATE (FASTEN PER FASTENING SCHEDULE)



ENDWALL HEADER FOR OPENINGS UP TO 9'-0" SIDEWALL HEADER FOR

DBL. 2x4 TOP PLATE (FASTEN PER FASTENING SCHEDULE)

(2) 2x4 w/ 7/16" OSB FLITCH PLATE (FASTEN PER FASTENING SCHEDULE)

OPTIONAL ENDWALL HEADER FOR OPENINGS UP TO 9'-0"

(1) 2x4 & (1) 2x8 w/ 7/16" OSB FLITCH PLATE (FASTEN PER FASTENING SCHEDULE)



OPTIONAL ENDWALL HEADER FOR OPENINGS UP TO 9'-0" OPTIONAL SIDEWALL HEADER

(MAX. SPAN 9'-0")

## 'NO-STRAP' HEADER DETAIL



ntertek-ATI (Architectural Testina) This document meets or exceeds the Requirements of the State of Florida Manufactured Building Rules & Regulations 2023 FBC with the Latest Supplements

Const. Type: VB Occupancy: S
Allowed Floors: 1
Fire Rating Ext. Walls: 0 hrs.
Wind Velocity: 160 mph Plan #: R-21252 Floor Load: 50 pst Approval Date: 2024-01-09

Ryan Knowles

Rvan Knowles



Bay Engineering, LLC 4177 Coporate CT Palm Harbor, FL 34683 FL Lic. # 53759 FL COA# 36094



CODE INFORMATION	
CODE VERSION	2023 FLORIDA BUILDING CODE 8TH EDITION, ASCE-22, 2020 NEC
MANUFACTURER	SOUTH COUNTRY SHEDS
BUILDING TYPE	MANUFACTURED BUILDING RESIDENTIAL LAWN STORAGE
CONSTRUCTION TYPE	V-B
FIRE PROTECTION	NONE
FIRE SUPPRESSION SYSTEM	NONE
OCCUPANCY	STORAGE
ALLOWABLE NUMBER OF STORIES	1
BASIC WIND SPEED	Vult-160 MPH
EXPOSURE	D
ENCLOSURE	ENCLOSED
INTERNAL PRESSURE COEFFICIENT	+/- 0.18
IMPORTANCE FACTOR	1.15
ROOF DEAD LOAD	10 PSF
ROOF LIVE LOAD	20 PSF OR 300LB POINT LOAD
FLOOR DEAD LOAD	10 PSF
FLOOR LIVE LOAD	50 PSF
"R" RATING OF WALLS, FLOOR, ROOF	N/A
MODULES PER BUILDING	1
HURRICANE PROTECTION USEAGE	NO
HURRICANE SHELTER USAGE	NO
SQUARE FOOTAGE	719 SQ. FT. OR LESS

**REVISIOINS** 

DESCRIPTION

	DRAWN BY:	RDH		-
DATE: 12/5/2023				
3/8"= 1'-0"				
	MODEL#:	000 5 4005		

DATE BY

### GENERAL NOTES

E

Ш

EADI

工

FOUNDATION PLANS ARE NOT PART OF THIS PLAN SET AND ARE GOVERNED BY LOCAL JURISDICTION. THIS BUILDING IS EXEMPT FROM THE FBC ENERGY


SCS-B-160D

- CONSERVATION CODE PER SECTION 1015.22.
- REFER TO TIE-DOWN DETAILS FOR PROPER INSTALLATION REQUIREMENTS TO MEET CODE.
- ALL STUDS, RAFTERS, TRUSSES, ETC. ARE 2x4 SPF#2, EXCEPT AS NOTED.
- STRUCTURES OVER 400 SQ. FT. WILL HAVE AN 80" MINIMUM DOOR.
- GUTTERS TO BE INSTALLED ON-SITE BY OTHERS THRU LOCAL CODES.
- ALL WINDOWS AND DOORS TO MEET THE MINIMUM SPECIFICATIONS AS PER FLORIDA BUILDING CODE.
- IN ACCORDANCE WITH FBC 1609.1.2. STORAGE SHEDS ARE NOT DESIGNED FOR HUMAN HABITATION WITH A FLOOR AREA OF LESS THAN 720 SQUARE FEET ARE NOT REQUIRED TO COMPLY WITH THE MANDATORY WINDBORNE DEBRIS IMPACT STANDARDS OF THE 2023 FBC.


IN ACCORDANCE WITH FBD 1008.1.1; BUILDINGS THAT ARE 400 SQUARE FEET OR LESS THAT ARE INTENDED FOR USE IN CONJUNCTION WITH ONE AND TWO FAMILY RESIDENCES ARE NOT SUBJECT TO THE DOOR HEIGHT AND WIDTH REQUIREMENTS OF THE FBC 2023.

IN ACCORDANCE WITH FLORIDA STATE STATUTE 553.80(1)d, LAWN STORAGE BUILDINGS AND STORAGE SHEDS BEARING THE INSIGNIA OF APPROVAL OF THE DEPARTMENT ARE NOT SUBJECT TO ₹553.842 (FLORIDA PRODUCT APPROVALS ARE NOT REQUIRED FOR WINDOWS, DOORS, OR OTHER COMPONENTS)

FBPR-4 OF 8 SHEET:

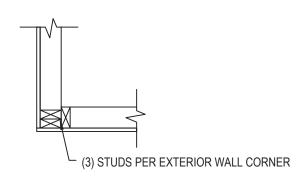


## **CORNER CONNECTION DETAIL**

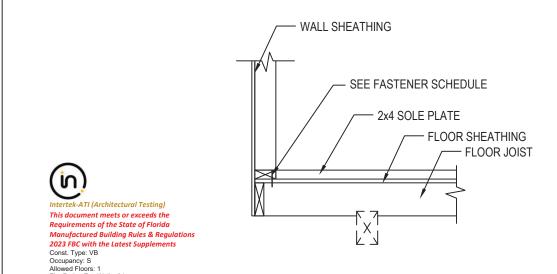

## WALL TO FLOOR **CONNECTION DETAIL**

## MITEK 2"x4" OR EQUAL TYP. INTERIOR EACH CORNER 2"x4" TYP. VARIES INTERIOR MEMBERS USE MITEK 2"x4" OR EQUAL OR NAILED PER [16] ON THE FASTENER SCHEDULE SHEATHING FOR DOOR SKIN SAME AS WALL SHEATHING 4' MAX

OPTIONAL WOOD FRAME DOOR CONSTRUCTION DETAIL

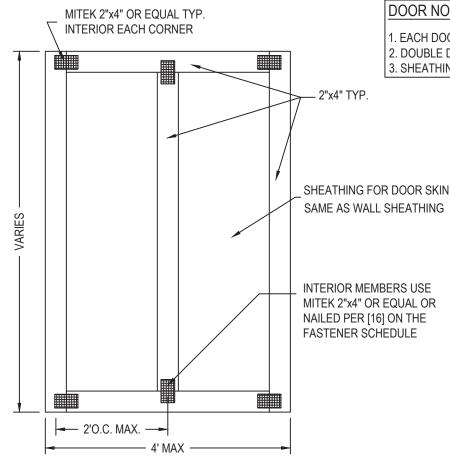

Fire Rating Ext. Walls: 0 hrs

Approval Date: 2024-01-09

Ryan Knowles

OPTIONAL WOOD FRAME DOOR CONSTRUCTION DETAIL

### **DOOR NOTES:**

- I. EACH DOOR HAS 3 HINGES WITH 8 SCREWS EACH 2. DOUBLE DOOR DESIGN IS SAME LAYOUT
- 3. SHEATHING IS FASTENED SAME AS TO STUD WALL

DET,

CONNECTION

D00R/

CODE VERSION

OCCUPANCY

ROOF DEAD LOAD ROOF LIVE LOAD

LOOR DEAD LOAD

MANUFACTURER BUILDING TYPE

CONSTRUCTION TYPE FIRE PROTECTION

FIRE SUPPRESSION SYSTE

FOUNDATION PLANS ARE NOT PART OF THIS PLAN SET AND ARE GOVERNED BY LOCAL JURISDICTION.

RDH

12/5/2023

3/4"= 1'-0" SCS-B-160D

NONE

NONE

STORAGE

Vult-160 MPH

ENCLOSED

20 PSF OR 300LB POINT LOAD

719 SQ. FT. OR LESS

DATE BY


THIS BUILDING IS EXEMPT FROM THE FBC ENERGY CONSERVATION CODE PER SECTION 1015.22. REFER TO TIE-DOWN DETAILS FOR PROPER

DESCRIPTION


- INSTALLATION REQUIREMENTS TO MEET CODE.
- ALL STUDS, RAFTERS, TRUSSES, ETC. ARE 2x4 SPF#2, EXCEPT AS NOTED.
- STRUCTURES OVER 400 SQ. FT. WILL HAVE AN 80' MINIMUM DOOR.
- GUTTERS TO BE INSTALLED ON-SITE BY OTHERS THRU LOCAL CODES.
- ALL WINDOWS AND DOORS TO MEET THE MINIMUM SPECIFICATIONS AS PER FLORIDA BUILDING CODE.
- IN ACCORDANCE WITH FBC 1609.1.2. STORAGE SHEDS ARE NOT DESIGNED FOR HUMAN HABITATION WITH A FLOOR AREA OF LESS THAN 720 SQUARE FEET ARE NOT REQUIRED TO COMPLY WITH THE MANDATORY WINDBORNE DEBRIS IMPACT STANDARDS OF THE 2023 FBC.
- ARE 400 SQUARE FEET OR LESS THAT ARE INTENDED RESIDENCES ARE NOT SUBJECT TO THE DOOR HEIGHT AND WIDTH REQUIREMENTS OF THE FBC 2023.
- IN ACCORDANCE WITH FLORIDA STATE STATUTE 553.80(1)d, LAWN STORAGE BUILDINGS AND STORAGE SHEDS BEARING THE INSIGNIA OF APPROVAL OF THE DEPARTMENT ARE NOT SUBJECT TO \$553.842 (FLORIDA PRODUCT APPROVALS ARE NOT REQUIRED FOR WINDOWS, DOORS, OR OTHER COMPONENTS)

SHEET:

FBPR-5 OF 8

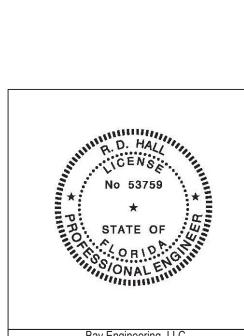

Bay Engineering, LLC 4177 Coporate CT Palm Harbor, FL 34683 FL Lic. # 53759 FL COA# 36094

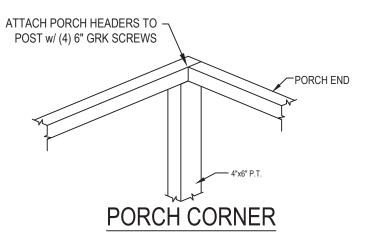





Floor Load: 50 psf Approval Date: 2024-01-09




FASTEN PORCH HEADER TO POST w/ (2) 6" GRK SCREWS

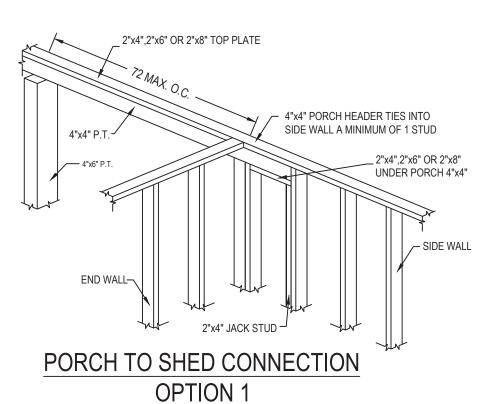

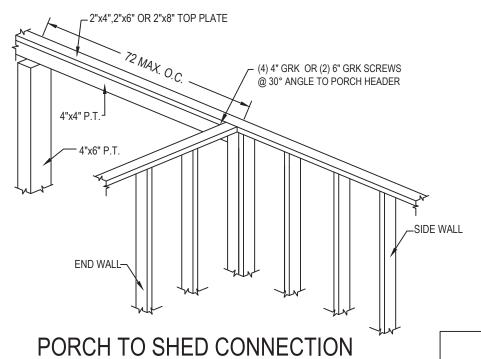

**OPTION 2** 

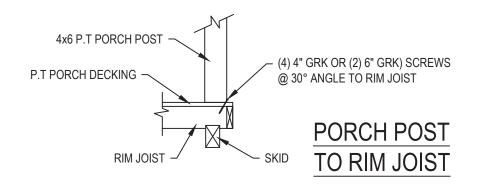



Bay Engineering, LLC 4177 Coporate CT Palm Harbor, FL 34683 FL Lic. # 53759 FL COA# 36094



CODE INFORMATION		
CODE VERSION	2023 FLORIDA BUILDING CODE 8TH EDITION, ASCE-22, 2020 NEC	
MANUFACTURER	SOUTH COUNTRY SHEDS	
BUILDING TYPE	MANUFACTURED BUILDING RESIDENTIAL LAWN STORAGE	
CONSTRUCTION TYPE	V-B	
FIRE PROTECTION	NONE	
FIRE SUPPRESSION SYSTEM	NONE	
OCCUPANCY	STORAGE	
ALLOWABLE NUMBER OF STORIES	1	
BASIC WIND SPEED	Vult-160 MPH	
EXPOSURE	D	
ENCLOSURE	ENCLOSED	
INTERNAL PRESSURE COEFFICIENT	+/- 0.18	
IMPORTANCE FACTOR	1.15	
ROOF DEAD LOAD	10 PSF	
ROOF LIVE LOAD	20 PSF OR 300LB POINT LOAD	
FLOOR DEAD LOAD	10 PSF	
FLOOR LIVE LOAD	50 PSF	
"R" RATING OF WALLS, FLOOR, ROOF	N/A	
MODULES PER BUILDING	1	
HURRICANE PROTECTION USEAGE	NO	
HURRICANE SHELTER USAGE	NO	
SQUARE FOOTAGE	719 SQ. FT. OR LESS	
BE: ((0)0)10	·	

	REVISIOINS		
REV	DESCRIPTION	DATE	BY
1			
2			
3			
	DRAWN BY:		

DRAWN BY:	RDH	
DATE:	12/5/2023	
SCALE:	1/2"= 1'-0"	
MODEL#:	SCS-B-160D	

### GENERAL NOTES:

- FOUNDATION PLANS ARE NOT PART OF THIS PLAN SET AND ARE GOVERNED BY LOCAL JURISDICTION.
   THIS BUILDING IS EXEMPT FROM THE FBC ENERGY
- CONSERVATION CODE PER SECTION 1015.22.

  3. REFER TO TIE-DOWN DETAILS FOR PROPER
- INSTALLATION REQUIREMENTS TO MEET CODE.
- 4. ALL STUDS, RAFTERS, TRUSSES, ETC. ARE 2x4 SPF#2, EXCEPT AS NOTED.
- STRUCTURES OVER 400 SQ. FT. WILL HAVE AN 80" MINIMUM DOOR.
- 6. GUTTERS TO BE INSTALLED ON-SITE BY OTHERS THRU LOCAL CODES.
- 7. ALL WINDOWS AND DOORS TO MEET THE MINIMUM SPECIFICATIONS AS PER FLORIDA BUILDING CODE.
- 8. IN ACCORDANCE WITH FBC 1609.1.2, STORAGE SHEDS
  ARE NOT DESIGNED FOR HUMAN HABITATION WITH A
  FLOOR AREA OF LESS THAN 720 SQUARE FEET ARE NOT
  REQUIRED TO COMPLY WITH THE MANDATORY
  WINDBORNE DEBRIS IMPACT STANDARDS OF
  THE 2023 FBC.
- IN ACCORDANCE WITH FBD 1008.1.1; BUILDINGS THAT
  ARE 400 SQUARE FEET OR LESS THAT ARE INTENDED
  FOR USE IN CONJUNCTION WITH ONE AND TWO FAMILY
  RESIDENCES ARE NOT SUBJECT TO THE DOOR HEIGHT
  AND WIDTH REQUIREMENTS OF THE FBC 2023.
- 10. IN ACCORDANCE WITH FLORIDA STATE STATUTE 553.80(1)d, LAWN STORAGE BUILDINGS AND STORAGE SHEDS BEARING THE INSIGNIA OF APPROVAL OF THE DEPARTMENT ARE NOT SUBJECT TO \$553.842 (FLORIDA PRODUCT APPROVALS ARE NOT REQUIRED FOR WINDOWS, DOORS, OR OTHER COMPONENTS)


SHEET: FBPR-6 OF 8

9. IN A ARI FOI PORCH 10. IN A STATE OF THE PROPERTY WIN


ET,

 $\Box$ 

 $\overline{\mathsf{O}}$ 

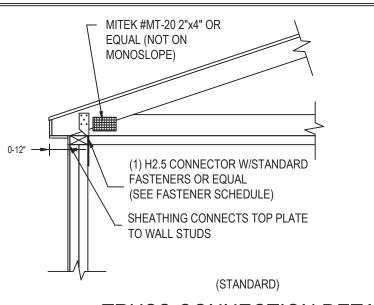

TRUSS CONNECTION DETAIL

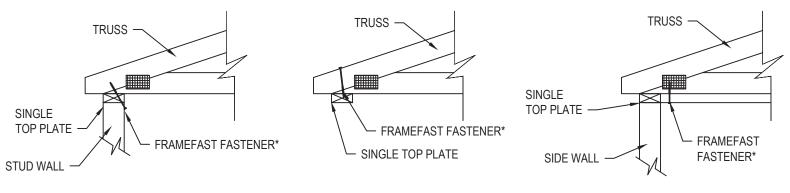

SIDE VIEW "A"

SIDE VIEW "B"

IN PLACE OF FRAMEFAST FASTENER)

(n)

Const. Type: VB

Floor Load: 50 psf Approval Date: 2024-01-09

Ryan Knowles

Occupancy: S
Allowed Floors: 1
Fire Rating Ext. Walls: 0 hrs.
Wind Velocity: 160 mph
Plan #: R-21252

This document meets or exceeds the Requirements of the State of Florida Manufactured Building Rules & Regula 2023 FBC with the Latest Supplements

END WALL TRUSS TO END WALL SINGLE TOP PLATE


(OPTIONAL SIMPSON SCREW FL APPROVAL 13975.2

IN PLACE OF FRAMEFAST FASTENER)

TRUSS TO SIDE WALL


**DOUBLE TOP PLATE** 

(OPTIONAL SIMPSON SCREW FL APPROVAL 13975.2

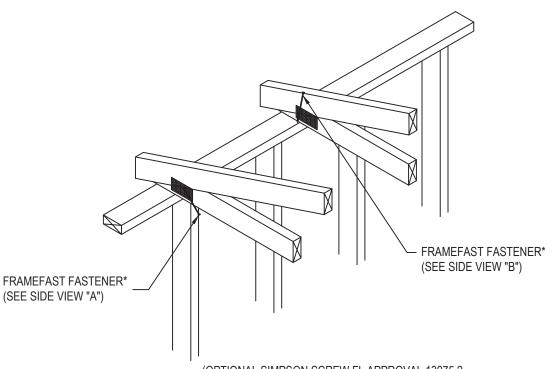

(OPTIONAL SIMPSON SCREW <u>FL APPROVAL 13975.2</u> IN PLACE OF FRAMEFAST FASTENER)

TRUSS CONNECTION DETAIL w/ OPTIONAL FASTENMASTER FRAMEFAST STRUCTURAL WOOD SCREWS (FL21662)

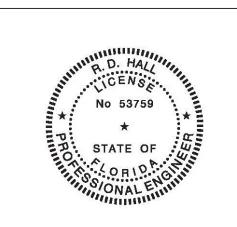

Bay Engineering, LLC 4177 Coporate CT Palm Harbor, FL 34683 FL Lic. # 53759 FL COA# 36094



CODE INFORMATION		
CODE VERSION	2023 FLORIDA BUILDING CODE 8TH EDITION, ASCE-22, 2020 NEC	
MANUFACTURER	SOUTH COUNTRY SHEDS	
BUILDING TYPE	MANUFACTURED BUILDING RESIDENTIAL LAWN STORAGE	
CONSTRUCTION TYPE	V-B	
FIRE PROTECTION	NONE	
FIRE SUPPRESSION SYSTEM	NONE	
OCCUPANCY	STORAGE	
ALLOWABLE NUMBER OF STORIES	1	
BASIC WIND SPEED	Vult-160 MPH	
EXPOSURE	D	
ENCLOSURE	ENCLOSED	
INTERNAL PRESSURE COEFFICIENT	+/- 0.18	
IMPORTANCE FACTOR	1.15	
ROOF DEAD LOAD	10 PSF	
ROOF LIVE LOAD	20 PSF OR 300LB POINT LOAD	
FLOOR DEAD LOAD	10 PSF	
FLOOR LIVE LOAD	50 PSF	
"R" RATING OF WALLS, FLOOR, ROOF	N/A	
MODULES PER BUILDING	1	
HURRICANE PROTECTION USEAGE	NO	
HURRICANE SHELTER USAGE	NO	
SQUARE FOOTAGE	719 SQ. FT. OR LESS	
REVISIOINS		

	REVISIOINS		
REV	DESCRIPTION	DATE	BY
1			
2			
3			
		,	
	DRAWN BV:		

DRAWN BY:	RDH		
DATE:	12/5/2023		
SCALE:	3/4"= 1'-0"		
MODEL#:	SCS-B-160D		

### GENERAL NOTES:

- FOUNDATION PLANS ARE NOT PART OF THIS PLAN SET AND ARE GOVERNED BY LOCAL JURISDICTION.
   THIS BUILDING IS EXEMPT FROM THE FBC ENERGY
- CONSERVATION CODE PER SECTION 1015.22.

  3. REFER TO TIE-DOWN DETAILS FOR PROPER
- INSTALLATION REQUIREMENTS TO MEET CODE.
- ALL STUDS, RAFTERS, TRUSSES, ETC. ARE 2x4 SPF#2, EXCEPT AS NOTED.
- STRUCTURES OVER 400 SQ. FT. WILL HAVE AN 80" MINIMUM DOOR.
- GUTTERS TO BE INSTALLED ON-SITE BY OTHERS THRU LOCAL CODES.
- ALL WINDOWS AND DOORS TO MEET THE MINIMUM SPECIFICATIONS AS PER FLORIDA BUILDING CODE.
- IN ACCORDANCE WITH FBC 1609.1.2, STORAGE SHEDS
   ARE NOT DESIGNED FOR HUMAN HABITATION WITH A
   FLOOR AREA OF LESS THAN 720 SQUARE FEET ARE NOT
   REQUIRED TO COMPLY WITH THE MANDATORY
   WINDBORNE DEBRIS IMPACT STANDARDS OF
   THE 2023 FBC.
- IN ACCORDANCE WITH FBD 1008.1.1; BUILDINGS THAT
  ARE 400 SQUARE FEET OR LESS THAT ARE INTENDED
  FOR USE IN CONJUNCTION WITH ONE AND TWO FAMILY
  RESIDENCES ARE NOT SUBJECT TO THE DOOR HEIGHT
  AND WIDTH REQUIREMENTS OF THE FBC 2023.
- 10. IN ACCORDANCE WITH FLORIDA STATE STATUTE
  553.80(1)d, LAWN STORAGE BUILDINGS AND STORAGE
  SHEDS BEARING THE INSIGNIA OF APPROVAL OF THE
  DEPARTMENT ARE NOT SUBJECT TO 表553.842 (FLORIDA
  PRODUCT APPROVALS ARE NOT REQUIRED FOR
  WINDOWS, DOORS, OR OTHER COMPONENTS)

SHEET: FBPR-7 OF 8

RUSS CONNECTION DETAIL

	Fastening Schedule{r}		29. Joist to band joist	3 – 16d common (3 1/2" x 0 4 – 3" x 0.131 nails	. 135")	face nail
	(FBC Table 2304.10.1)			4 – 3" 14 gage staples		lace riali
Connection	Fastening(a.m)	Location	30. Ledger strip	3 – 16d common (3 1/2" x 0	. 162")	
Joist to sill or airder	3 – 8d commom (2 1/2" x 0.131")			4 - 3" x 0.131 nails		Face nail at each joint
. Joint to sill of glider	3 – 3" 14 gage staples	toenail		4 – 3" 14 gage staples		
Bridging to joist	2 – 8d common (2 1/2" x 0.131")		31. Wood structural panels and particleboard(b)	1/2" and less	6d{c, I, q}	
	2 – 3" x 0.232" nails	toenail each end	Subfloor, roof and wall sheathing (to framing)		2 3/8" x 0.113" nail{n}	
	2 – 3" 14 gage staples				1 3/4" 16 gage{o}	
1" x 6" subfloor or less to each joist	2 – 8d common (2 1/2" x 0.131")	face nail		1		
Wider than 1" x 6" subfloor to each joist	3 - 8d commom (2 1/2" x 0.131")	face nail	Single floor (combination subfloor-underlayment	to 19/32" to 3/4"	8d{d} or 6d{e}	
2" subfloor to joist or girder	2 - 16d common (3 1/2" x 0.162")	blind and face nail	framing)		2 3/8" x 0.113" nail{p}	6" o.c. Edges and intermediate, 4" o.c. at
Sole plate to joist or blocking	16d (3 1/2" x 0.135") at 16" o.c.				2" 16 gage{p}	component and cladding edge strip # zone
, ,	3" x 0.131 nails at 8" o.c.	Typical face nail		7.00	0.14.3	[refer to Figure 30.5-1 of ASCE 7]
	3" 14 gage staples at 12" o.c.			7/8" to 1" 1 1/8" to 1 1/4"	8d(c)	
				1 1/8 to 1 1/4	10d{d} or 8d{d}	
Sole plate to joist at blocking at braced wall	3 - 16d common (3 1/2" x 0.135") at 16" o.c.			3/4" and less	6d{c}	
anel	4 – 3" x 0.131" nails at 16" o.c.	braced wall panel		7/8" to 1"	60{c} 8d{c}	
	4 - 3" 14 gage staples at 16" o.c.			1 1/8" to 1 1/4"	10d(d) or 8d(d)	
Top plate to stud	2 - 16d common (3 1/2" x 0.162")		22 Deceleration to form (a)	1/2" or less	100(a) or 80(a) 6d(f)	
	3 – 3" x 0.131" nails	end nail	32. Panel siding (to framing){q}	1/2" or less 5/8"	60(f) 8d(f)	
	3 – 3" 14 gage staples		22 Fiberhand shouthing(s.e.)	1/2" and less		
Stud to sole plate	4 – 8d common (2 1/2" x 0.131")		33. Fiberboard sheathing(g,q)	1/2 and less	No. 11 gage roofing nail{h} 6d common nail (2" x 0.113")	
	4 - 3" x 0.131" nails	toenail			No. 16 gage staple(i)	
	3 – 3" 14 gage staples			25/32"	No. 16 gage staple(I)  No. 11 gage roofing nail(h)	6" o.c. Edges and intermediate
				25/32	8d common nail (2 1/2" x 0.131")	
	2 - 16d common (3 1/2" x 0.162")				No. 16 gage staple(i)	
	3 – 3" x 0.131" nails	end nail	04.11.	4 / 4 m		
	3 – 3" 14 gage staples		34. Interior paneling	1/4" 3/8"	4d{}	6" o.c. Edges and intermediate
Double studs	16d (3 1/2" x 0.135") at 24" o.c.		a. Common or box nails are permitted to be use		6d{k}	
	3" x 0.131" nail at 8" o.c.	face nail				40 ib
	3" 14 gage staples at 8" o.c.		Nails spaced at 6 inches on center at edges, wood structural panel and particleboard diaple			
Double top plates	16d (3 1/2" x 0.135") at 16" o.c.		c. Common or deformed shank (6d - 2" x 0.113"			are permitted to be common, box or casing.
	3" x 0.131" nail at 8" o.c.	Typical face nail	d. Common (6d - 2" x 0.113"; 8d - 2 1/2" x 0.13		X 0. 140 ).	
	3" 14 gage staples at 8" o.c.		e. Deformed shank (6d - 2" x 0.113"; 8d - 2 1/2"			
			f. Corrosion-resistant siding (6d - 1 7/8" x 0.10		ng /6d   2" v 0 000": 8d   2 1/2" v 0 112	"\ nail
Double top plates	8 - 16d common (3 1/2" x 0.162")		g. Fasteners spaced 3 inches on center at exte			
	12 - 3" x 0.131" nails	lap splice	inches on center on the edges and 12 inches			as structural sheathing. Spacing shall be o
	12 - 3" 14 gage staples		h. Corrosion-resistant roofing nails with 7/16-ing			inch length for 25/32 inch cheathing
1. Blocking between joists or rafters to top plate	3 – 8d common (2 1/2" x 0.131")		i. Corrosion-resistant staples with nominal 7/16			
	3 – 3" x 0.131" nails	toenail	Panel supports at 16 inches (20 inches if str			
	3 – 3" 14 gage staples		i. Casing (1 1/2" x 0.080") or finish (1 1/2" x 0.0			
2. Rim joist to top plate	8d (2 1/2" x 0.131") at 6" o.c.		k. Panel supports at 24 inches. Casing or finis			
	3" x 0.131 nails at 6" o.c.	toenail	For roof sheathing applications, 8d nails (2.1.)			ларропо.
	3" 14 gage staples at 6" o.c.		m. Staples shall have a minimum crown width o		required for wood etractural pariole.	
Top plates, laps and intersections	2 - 16d common (3 1/2" x 0.162")		n. For roof sheathing applications, fasterners sp		edges 8 inches at intermediate support	s
	3 – 3" x 0.131" nails	face nail	o. Fasteners spaced at 4 inches on center at e			
	3 – 3" 14 gage staples		intermediate supports for roof sheathing.		and because of the second of t	and a manage an administration and adjust a manage at
4. Continuous header, two pieces	16d common (3 1/2" x 0.162")	16" o.c. Along edge	p. Fasteners spaced at 4 inches on center at e	lges. 8 inches at intermediate	supports.	
5. Ceiling joists to plate	3 - 8d common (2 1/2" x 0.131")		g. See Fastener Alternate Schedule.		• •	
•	5 – 3" x 0.131" nails	toenail	r. Fasteners must be installed with even spacing	g between them across attach	ning member.	
	3 – 3" 14 gage staples		· ·			
Continuous header to stud	4 – 8d common (2 1/2" x 0.131")	toenail	Alternate F	astening Schedule		
. Ceiling joists, laps over partitions	3 - 16d common (3 1/2" x 0.135") minimum, Table 2308.10.4.1					
(See Table 2308.10.4.1)	4- 3" x 0.131 nails	face nail	Connection		stening	
*	4 – 3" 14 gage staples		ALT 31-33. Wood structural panels and particle		2" x 0.092" Ring Shank Nail -	
Ceiling joists to parallel rafters	3 – 16d common (3 1/2" x 0.135") minimum, Table 2308.10.4.1		Subfloor, roof and wall sheathing (to framing	1)	5" from edge, 10" o.c.	
(See Table 2308.10.4.1)	4 - 3" x 0.131 nails	f ::-:!			<u> </u>	,
	4 – 3" 14 gage staples	face nail	Strap & Simpson Stron	<u>g-Drive® SD S</u> crew	Schedule	Strap & Fastene
). Rafter to plate	3 - 8d common (2 1/2" x 0.131")		Part#/Desc. Uplift	Wall fastener Rafter F		Part#/Desc. Uplift Wa
9. Rafter to plate	3 – 8d common (2 1/2" x 0.131") 3 – 3" x 0.131" nails	toenail	Part#/Desc. Uplift H1 435 H11Z 750	- 6-SD9 - 6-SD1	x1.5" 4-SD9x1.5"	Part#/Desc. Uplift Wa H1 400 H11Z 750

2 - 8d common (2 1/2° x 0.131°)

2 – 3" x 0.131 nalis 3 – 3" 14 gage staples 3 – 8d common (2 1/2" x 0.131") 3 – 8d common (2 1/2" x 0.131") 16d common (3 1/2" x 0.162") 3" x 0.131 nails

3" 14 gage staples 20d common (4" x 0.192") at 32" o.c. 3" x 0.131" nails at 24" o.c. 3" 14 gage staples at 24" o.c.

2-20 common (4" x 0.192") 3 – 3" x 0.131" nails

16d common (3 1/2" x 0.162") 3 – 10d common (3" x 0.148")

4 – 3" 14 gage staples 3 – 10d common (3" x 0.148")

2 – 16d common (3 1/2" x 0.162") 3 – 3" x 0.131" nails

3 - 3" 14 gage staples ! - 16d common (3 1/2" x 0.162

2 – 16d common (3 1/2" x 0.162") 3 – 3" x 0.131" nails

3 – 3" 14 gage staples

4 - 3" x 0 131 nails

4 - 3" 14 gage staples

3 - 3" x 0 131" nails

3 – 3" 14 gage staples

3 – 3" 14 gage staples

face nail

16" o.c.

at each bearing

face nail

face nail

toenail

face nail at top and bottom staggered on

face nail at ends and at each splice

2 – 3" x 0.131 nails

20. 1" Diagonal brace to each stud and plate

21. 1" x 8" sheathing to each bearing
22. Wider than 1" x 8" sheathing to each bearing
23. Built-up corner suds

24. Built-up girder and beams

25. 2" planks 26. Collar tie to rafter

27. Jack rafter to hip

28. Roof rafter to 2-by ridge beam



This document meets or exceeds the

Requirements of the State of Florida Manufactured Building Rules & Regulations 2023 FBC with the Latest Supplements

Const. Type: VB Occupancy: S Allowed Floors: 1 Fire Rating Ext. Walls: 0 hrs. Wind Velocity: 160 mph Plan #: R-21252 Floor Load: 50 psf Approval Date: 2024-01-09

Ryan Knowles Ryan Knowles

hodulo (a)

Strap & Simpson Strong-Drive® 3D Screw Schedule					Strap & Pasterier Schedule (a)						
	Part#/Desc.	Uplift	Wall fastener	Rafter Fastener	Plate Fastener		Part#/Desc.	Uplift	Wall fastener	Rafter Fastener	Plate Fastener
	H1	435	-	6-SD9x1.5"	4-SD9x1.5"		H1	400	-	6-8dx 1/5"	4-8d
	H11Z	750	-	6-SD10x2.5"	6-SD10x2.5"		H11Z	750	-	6-16dx2.5"	6-16dx2.5"
	H2A	495	5-SD9x1.5"	5-SD9x1.5"	2-SD9x1.5"		H2A	495	5-8dx1.5"	5-8dx 1.5"	2-8dx1.5"
	H2.5A	540	-	5-SD9x1.5"	5-SD9x1.5"		H2.5A	535	-	5-8d	5-8d
	H2.5	410	5-SD9x1.5"	5-SD9x1.5"	-		H2.5	410	5-8d	5-8d	-
	H2.5T	545	5-SD9x1.5"	5-SD9x1.5"	-		H2.5T	545	5-8d	5-8d	-
	H2A	495	7-SD9x1.5"	5-SD9x1.5"	-	Rafter{b}	H2A	495	7-8dx1.5"	5-8dx 1.5"	-
	H3	320	4-SD9x1.5"	4-SD9x1.5"	-		H3	320	4-8d	4-8d	-
Rafter	H4	280	4-SD9x1.5"	4-SD9x1.5"	-		H4	235	4-8d	4-8d	-
Raitei	H5	415	4-SD9x1.5"	4-SD9x1.5"	-		H5	265	4-8d	4-8d	-
	LTS-12	895	6-SD9x1.5"	6-SD9x1.5"	-		LTS-12	620	6-10dx1.5"	6-10dx 1.5"	-
	LTS-16	1075	6-SD9x1.5"	6-SD9x1.5"	-		LTS-16	620	6-10dx1.5"	6-10dx 1.5"	-
	LTS-18	1235	6-SD9x1.5"	6-SD9x1.5"	-		LTS-18	620	6-10dx1.5"	6-10dx 1.5"	-
	LTS-20	1215	6-SD9x1.5"	6-SD9x1.5"	-		LTS-20	620	6-10dx1.5"	6-10dx 1.5"	-
	MTS-12	895	7-SD9x1.5"	7-SD9x1.5"	-		MTS-12	860	7-10dx1.5"	7-10dx 1.5"	-
	MTS-16	1075	7-SD9x1.5"	7-SD9x1.5"	-		MTS-16	860	7-10dx1.5"	7-10dx 1.5"	-
	MTS-18	1255	7-SD9x1.5"	7-SD9x1.5"	-		MTS-18	860	7-10dx1.5"	7-10dx 1.5"	-
	MTS-20	1255	7-SD9x1.5"	7-SD9x1.5"	-		MTS-20	860	7-10dx1.5"	7-10dx 1.5"	-

				to the second		
	Part#/Desc.	Uplift	Wall fastener	Floor Fastener		
Wall to Floor{a}	LSTA-18	1,235	7-SD9x1.5"	7-SD9x1.5"		
	Part#/Desc.	Uplift	Wall fastener	Floor Fastener		
Tie-Downs	20Ga. 1-1/4" Wide	4,725	7-SD9x1.5"	-		
He-DOWIIS	5/8"x 30" Anchor	4,300	-	-		
a. Only needed on aluminum sheathing walls.						

. Headers over 6' span.

	Part#/Desc.	Uplift	Wall fastener	Floor Fastener
Wall to Floor(c)	LSTA-18	1,110	7-10d	7-10d
	Part#/Desc.	Uplift	Stud fastener	Header Fastener
Header{d}	TP-35	N/R	5-3"x 0.131"	5-3"x 0.131"
rieaderius	HP40,41,80,81	4,725	5-3"x 0.131"	5-3"x 0.131"
	Part#/Desc.	Uplift	Wall fastener	Floor Fastener
Tie-Downs	20Ga. 1-1/4" Wide	4,725	7-10dx1.5"	-
HE-POWIIS	COULTON A	4 200		

- a. All straps can be substituted with an equivalent brand meeting same strengths.
- b. Rafter ties to stud wall to be at every connection for 24" o.c. & can be every other for 16" o.c. but is required on corners and studs adjacent to corners.
- c. Only needed on aluminum & vinyl sheathing walls.
- d. Headers over 6' span.



Bay Engineering, LLC 4177 Coporate CT Palm Harbor, FL 34683 FL Lic. # 53759 FL COA# 36094



	CODE IN ON	17 (110)		
CODE	VERSION	2023 FLORIDA BUILDING CODE 8TH EDITION, ASCE-22, 2020 NEC		
MANUE	ACTURER	SOUTH COUNTRY SHEDS		
BUILDING TYPE MANUFACTURED BUILDING RESIDENTIAL LAWN STORAL				
CONSTRUCTION TYPE V-B				
FIRE P	ROTECTION	NONE		
FIRE S	UPPRESSION SYSTEM	NONE		
OCCU	PANCY	STORAGE		
ALLOV	/ABLE NUMBER OF STORIES	1		
BASIC	WIND SPEED	Vult-160 MPH		
EXPOS	BURE	D		
ENCLO	SURE	ENCLOSED		
INTERI	NAL PRESSURE COEFFICIENT	+/- 0.18		
IMPOR	TANCE FACTOR	1.15		
ROOF	DEAD LOAD	10 PSF		
ROOF	LIVE LOAD	20 PSF OR 300LB POINT LOAD		
FLOOF	R DEAD LOAD	10 PSF		
FLOOF	R LIVE LOAD	50 PSF		
"R" RA	TING OF WALLS, FLOOR, ROOF	N/A		
MODU	LES PER BUILDING	1		
HURRI	CANE PROTECTION USEAGE	NO		
HURRI	CANE SHELTER USAGE	NO		
SQUAF	RE FOOTAGE	719 SQ. FT. OR LESS		
	REVISIOINS	•		
REV	DATE BY			

	DRAWN BY:	RDH	
	DATE:	12/5/2023	
	SCALE:	N/A	
	MODEL#:	SCS B 160D	

### GENERAL NOTES:

- FOUNDATION PLANS ARE NOT PART OF THIS PLAN SET AND ARE GOVERNED BY LOCAL JURISDICTION. THIS BUILDING IS EXEMPT FROM THE FBC ENERGY
- CONSERVATION CODE PER SECTION 1015.22.
- REFER TO TIE-DOWN DETAILS FOR PROPER INSTALLATION REQUIREMENTS TO MEET CODE.
- ALL STUDS, RAFTERS, TRUSSES, ETC. ARE 2x4 SPF#2, EXCEPT AS NOTED.
- STRUCTURES OVER 400 SQ. FT. WILL HAVE AN 80" MINIMUM DOOR.
- GUTTERS TO BE INSTALLED ON-SITE BY OTHERS THRU LOCAL CODES.
- ALL WINDOWS AND DOORS TO MEET THE MINIMUM SPECIFICATIONS AS PER FLORIDA BUILDING CODE.
- IN ACCORDANCE WITH FBC 1609.1.2, STORAGE SHEDS ARE NOT DESIGNED FOR HUMAN HABITATION WITH A FLOOR AREA OF LESS THAN 720 SQUARE FEET ARE NOT REQUIRED TO COMPLY WITH THE MANDATORY WINDBORNE DEBRIS IMPACT STANDARDS OF THE 2023 FBC.
- IN ACCORDANCE WITH FBD 1008.1.1; BUILDINGS THAT ARE 400 SQUARE FEET OR LESS THAT ARE INTENDED FOR USE IN CONJUNCTION WITH ONE AND TWO FAMILY RESIDENCES ARE NOT SUBJECT TO THE DOOR HEIGHT AND WIDTH REQUIREMENTS OF THE FBC 2023.
- IN ACCORDANCE WITH FLORIDA STATE STATUTE 553.80(1)d, LAWN STORAGE BUILDINGS AND STORAGE SHEDS BEARING THE INSIGNIA OF APPROVAL OF THE DEPARTMENT ARE NOT SUBJECT TO \$553.842 (FLORIDA PRODUCT APPROVALS ARE NOT REQUIRED FOR WINDOWS, DOORS, OR OTHER COMPONENTS)

FBPR-8 OF 8 SHEET:

Ш STENE

EDUL SCHE

Ž

Щ