## GENERAL NOTES: FOR MAX FRAME LONG DIMENSION. 1. THIS PRODUCT HAS BEEN TESTED, ANALYZED & APPROVED FOR DESIGN PRESSURES NOT TO EXCEED THOSE SFF SINGLE WINDOW SIZE TABLE ON THIS SHEET SHOWN IN THE "ALLOWABLE DESIGN PRESSURE TABLE(S)". 2. OPENINGS, BUCKING & BUCKING FASTENERS MUST BE PROPERLY DESIGNED & INSTALLED TO TRANSFER WIND 12" MAX. O.C. LOADS TO THE STRUCTURE 6" MAX ALL HARDWARE & FASTENERS SHALL BE IN ACCORDANCE WITH THESE DRAWINGS & SHALL NOT VARY UNLESS (ALL SIDES) 2 SPECIFICALLY MENTIONED ON THE DRAWINGS. SPECIFIED ANCHOR EMBED TO BASE MATERIAL SHALL BE BEYOND WALL THIS PRODUCT HAS BEEN DESIGNED IN ACCORDANCE WITH AND MEETS THE REQUIREMENTS OF THE FLORIDA BUILDING CODE (FBC) INCLUDING HIGH VELOCITY HURRICANE ZONES (HVHZ) & IS LARGE MISSILE IMPACT RATED. BOILDING CODE (FBC) INCLUDING HIGH VICEOUTH TOURSELECT FOR CONTROL OF THE PROPERTY OF THE PROP OF RESISTING CORROSION CAUSED BY THE PRESSURE TREATING CHEMICALS IN THE WOOD. DETERMINE THE POSITIVE & NEGATIVE DESIGN LOADS TO USE WHEN REFERENCING THESE DOCUMENTS IN FRAME SHORT EE SINGLE WINDOW -ON THIS SHEET ACCORDANCE WITH THE GOVERNING CODE AND GOVERNING WIND VELOCITY. FOR WIND LOAD CALCULATIONS IN ACCORDANCE WITH THE FLORIDA BUILDING CODE, A DIRECTIONALITY FACTOR OF Kd = 0.85 MAY BE APPLIED PER THE ASULE / SUMPUNKU. B. MATERIALS, INCLUDING BUT NOT LIMITED TO STEEL SCREWS, THAT COME INTO CONTACT WITH OTHER DISSIMILAR MATERIALS SHALL MEET THE REQUIREMENTS OF FLORIDA BUILDING CODE. 3.25" TYPICAL FRAME SCREW OR MOUNTING CLIP. SEE 9. TO THE BEST OF OUR KNOWLEDGE, THE PRODUCT SHOWN HEREIN IS QUALITY ASSURED BY A FLORIDA STATE 9. IO THE BEST OF OUR KNOWLEDGE, THE PRODUCT SHOWN HEREIN IS QUALIT ASSURED IN A FLORIDA STATE APPROVED CERTIFICATION, AD ENTITY & SHALL BE LABELED IN ACCORDANCE WITH THE FEC AND THE FLORIDA DEPARTMENT OF BUSINESS & PROFESSIONAL REQULATION SPECIFICATIONS. THESE DRAWINGS SHOW ALL APPLICABLE ELEVATION, COMBINATION, INSTALLATION & COMPARATIVE ANALYSIS CONDITIONS AS DEFERMINED THOSE HESTING & ENGINEERING RATIONAL ANALYSIS. PRODUCT ASSEMBLY SHALL BE IN ACCORDANCE WITH THESE DRAWINGS, THE "FRAME ANCHOR REQUIREMENTS TABLE" SIMII AR Ĭ ON THIS SHEET FOR ₹ SCREW REQUIREMENTS. ON, SEE MANUFACTURER'S QUALITY ASSURANCE SPECIFICATIONS & TESTING REPORTS. Н 10. CERTIFICATION OF THIS PRODUCT SHALL BE CONSIDERED VIOLID IT IT IS INSTALLED WITHOUT A BUILDING PERMIT FROM THE APPLICABLE LOCAL BUILDING DEPARTMENT OR IF IT IS INSTALLED BY ANYONE OTHER THAN A LICENSED CONTRACTOR EXPERIENCED WITH INSTALLATIONS OF THIS TYPE OF PRODUCT. o. D.L.O. = F.W. - 3.25" 11. ALL WOOD MEMBERS OF THIS PRODUCT THAT MAY POSSIBLY COME INTO CONTACT WITH MASONRY OR CONCRETE 0 SUBSTRATES, ARE SUBJECT TO MOISTURE &/OR ARE SUBJECT TO THE OUTSIDE ENVIRONMENT SHALL BE OF AN APPROVED DURABLE SPECIES OR BE TREATED IN AN APPROVED METHOD WITH AN APPROVED PRESERVATIVE PER FBC OPPOSITE SEE "CORNER $\frac{A}{2}$ DETAIL" ON APPROVED SHAPES EVALUATION OF THIS PRODUCT IS BASED ON SHEET 3 APPLICABLE STANDARDS AND/OR INFORMATION & RESULTS FROM APPLICABLE TEST REPORTS. THE FLORIDA BUILDING CODE VERSION CONSIDERED WITH THIS EVALUATION WAS THAT IN FORCE AT THE TIME OF THE EVALUATION. IN EXTERIOR ELEVATION THE EVENT OF CODE VERSION CHANGES/UPDATES OR IN THE EVENT THAT NEW RECTANGULAR WINDOW OR ADDITIONAL TESTING IS COMPLETED ON THIS FOR LARGE UNITS WHERE THE BENT JAMB PRODUCT, PRIOR TO STATING CODE COMPLIANCE REQUIRES MORE THAN ONE SECTION LENGTH. WITH THE STATE. THE MANUFACTURER SHALL THE JAMB SHALL BE RABBITTED (11" LONG CONFIRM WITH THE EVALUATION ENGINEER OF RABIT JOINT), SET SCREWED WITH NO. 6 RECORD THAT EVERYTHING SPECIFIED HERE-IN IS CURRENT WITH ALL CURRENT TESTING, CODES SCREWS AND GLUED WITH WOOD GLUE. AND APPLICABLE STANDARDS. NOTES ALTERNATE ANCHOR/SUBSTRATE EVALUATION NOTE: . OTHER SHAPES MAY APPLY PROVIDING THEY ALL ALTERNATE ANCHORS IN THEIR SPECIFIED SUBSTRATES HAVE BEEN ANALYZED IN ACCORDANCE ARE SIMILAR TO THOSE SHOWN & HAVE CORNER CONSTRUCTION PER CORNER DETAILS. ALL SHAPED UNITS MUST FIT INSCRIBED INTO WITH THEIR APPLICABLE STANDARD(S) AND ARE FOUND THE ALLOWABLE RECTANGULAR UNITS & BE

98 50 96 51 90 54 SIGNATURE DOOR, INC. 401 PRIORITY STREET ALTOONA, PA 16602 800-741-2265 58 84 78 62 72 68 70 70 6" MAX. . ALL SIZES IN TABLE ARE BASED ON TESTED SIZES & DO NOT EXCEED THE WINDOW AREA TESTED. 2. LONG DIMENSION MAY BE HORIZONTAL SCALE: 3/4"=1'-0" (LONG DIMENSION MAY BE HORIZONTAL OR VERTICAL) WINDOW OR VERTICAL 3. DIMENSIONS SHOWN 12" MAX. O.C. ARE +/-1/2" NSULTANTS
W. SCHAEFER ENGINEERING
V. W. SCHAEFER ENGINEERING
CONSULTING, P.A. (CA 6809)
7480 150TH COURT NORTH
PALLY BEACH GRODER, IN 33418
PRINKE, 561–7444–7424 (ALL SIDES) IMPACT ALLOWABLE DESIGN PRESSURE HORT WINDOW : SHEET GLAZED +65/-75 PSF FOR MAX. FRAME SH DIMENSION, SEE SINGLE SIZE TABLE ON THIS S TYPICAL FRAME SCREW-DIRECT OR MOUNTING CLIP. SEE "FRAME ANCHOR REQUIREMENTS TABLE' A SCHAMENT 11 ON THIS SHEET FOR ļ. SCREW REQUIREMENTS. ું જ 0. -SEE "CORNER OPPOSITE DETAIL" ON  $\frac{A}{2}$ SHEET 3 2017 0 ್ರಿಕ್ 6" MAX. D.L.O. = F.W. - 3.25" FOR MAX. FRAME LONG DIMENSION, SEE SINGLE WINDOW SIZE TABLE ON THIS SHEET NAMAW. EXTERIOR ELEVATION HALF ROUND WINDOW 1780 (OTHER RADIUS/CURVE SHAPES SIMILAR) SHEET NO. SCALE: 3/4"=1'-0" (LONG DIMENSION MAY BE HORIZONTAL OR VERTICAL) OF

THESE DRAWINGS ARE APPLICABLE ONLY TO THE PRODU SPECIFIED. THEY MAY NOT BE USED FOR THE ASSEMBLY

AND OR INSTALLATION OF ANY OTHER PRODUCT NOR MAY

THEY BE USED FOR RATIONAL AND/OR LOCAL APPROVAL OF ANY PRODUCT NOT PRODUCED BY THE MANUFACTURES STATED ON THESE DRAWINGS.

ALLOWABLE SIZE

TABLE

(SINGLE WINDOW)

MAXIMUM FRAME

SHORT

DIMENSIO

(IN.)

34

37

40

45

S 4 5

MAXIMUM

FRAME

LONG

DIMENSION

(IN.)

144

132

120

108

6" MAX.

SIMIL AR

6" MAX.

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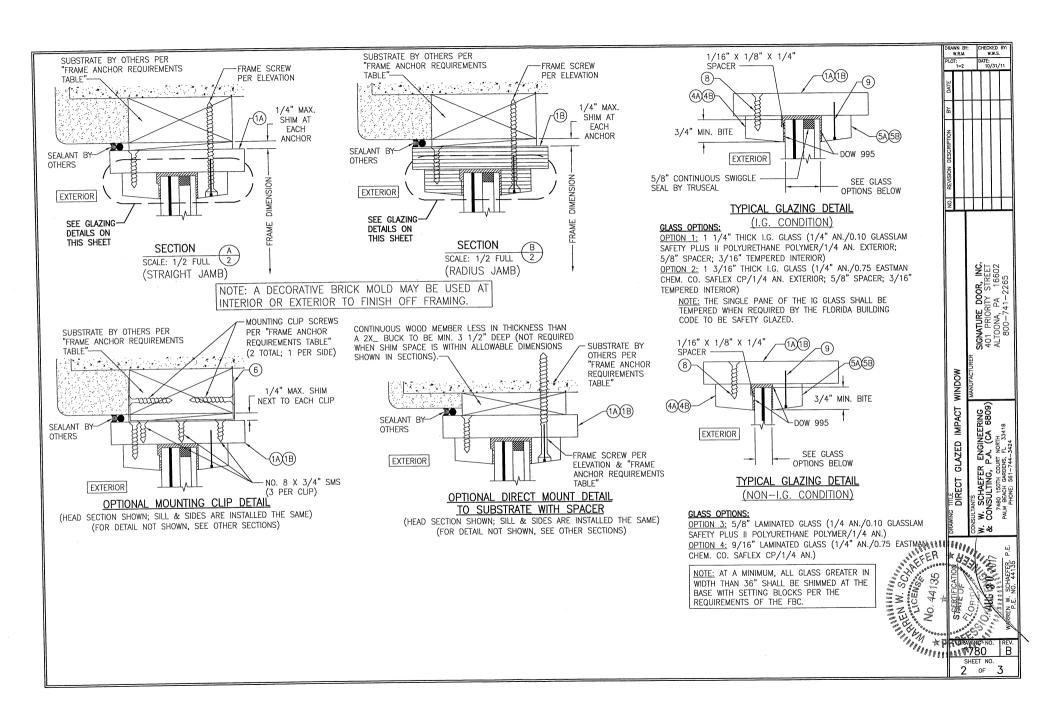
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GOVERNED BY THE ALLOWABLE PRESSURE OF THE RESPECTIVE RECTANGULAR UNIT.

TO BE EQUIVALENT TO OR STRONGER THAN THE ANCHOR(S) USED IN TESTING WITH THIS PRODUCT.


FRAME ANCHOR REQUIREMENTS TABLE					
OPENING TYPE (SUBSTRATE)	FRAME/CLIP TO OPENING FASTENER TYPE	MINIMUM EMBED	MINIMUM EDGE DIST.		
FRAME SCREWS					
MIN. 2X4 WOOD FRAME OR BUCK (MIN. GR. 3 & G=0.55)	NO. 10 SMS OR WOOD SCREW	1 1/4"	3/4"		
MIN. 18 GA. 33 KSI METAL STUD	NO. 10 GR. 5 SELF TAP/DRILL SCREW	FULL	1/2"		
MIN. 1/8" THK A36 STEEL	NO. 10 GR. 5 SELF TAP/DRILL SCREW	FULL	1/2"		
MIN. 1/8" THK 6063-T5 ALUM.	NO. 10 GR. 5 SELF TAP/DRILL SCREW		1/2"		
MIN. C-90 CMU OR 2500 PSI CONCRETE	(1) 1/4" CONCRETE SCREW	1 1/4"	2"		
MOUNTING CLIP SCREWS					
MIN. 2X4 WOOD FRAME OR BUCK (MIN. GR. 3 & G=0.55)	NO. 8 SMS SCREW 1 3/8"		1/2"		
MIN. 18 GA. 33 KSI METAL STUD	NO. 8 GR. 5 SELF TAP/DRILL SCREW	FULL	1/2"		
MIN. 1/8" THK A36 STEEL	NO. 8 GR. 5 SELF TAP/DRILL SCREW	FULL	1/2"		
MIN. 1/8" THK 6063-T5 ALUM.	NO. 8 GR. 5 SELF TAP/DRILL SCREW	FULL	1/2"		
(1) CONCRETE SCREWS SHALL BE ELCO ULTRACONS, ELCO CRETE-FLEX, ITW RAMSET/RED					

HEAD TAPCONS OR HILTI KWIK-CON II (HARDENED STEEL OR S.S.).




ITEM #	ITEM DESCRIPTION	MANUFACTURER/NOTES	
PARTS			
1A	1A STRAIGHT WINDOW JAMB * WOOD		
1B	RADIUS JAMB	LVL	
4A	ALT. EXTERIOR STOP (STRAIGHT JAMB)	* WOOD	
4B	ALT. EXTERIOR STOP (RADIUS JAMB)	LVL	
5A	ALT. INTERIOR STOP (STRAIGHT JAMB)	* WOOD	
5B	ALT. INTERIOR STOP (RADIUS JAMB)	LVL	
6	MOUNTING CLIP (0.044" X 1.625" X 6.500")	18 GA. GALVANIZED STEEL	
FASTENERS			
7	NO. 6 X 1 1/4" SMS	6" FROM ENDS & 12" MAX. O.C.	
8	1 1/4" DRYWALL SCREW	2" FROM ENDS & 8" MAX. O.C.	
9	1 3/16" BRAD NAIL	1" FROM CORNERS & 8" MAX. O.C.	

NOTE: WOOD USED IN TESTING WAS EASTERN WHITE PINE WITH A SPECIFIC GRAVITY OF G = 0.36 AND A MODULUS OF ELASTICITY OF E = 1,200,000 PSI. OTHER WOOD SPECIES APPLICABLE FOR USE WITH THIS PRODUCT ARE THOSE WITH A SPECIFIC GRAVITY OF 0.36 AND MODULUS OF ELASTICITY OF 1,200,000 PSI OR GREATER. ALL WOOD IS MINIMUM GRADE 2 MILLED BY SIGNATURE DOOR INC. TO SELECT.

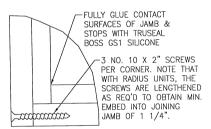


TYP. CORNER DETAIL TYP. AT ALL WINDOW SHAPES

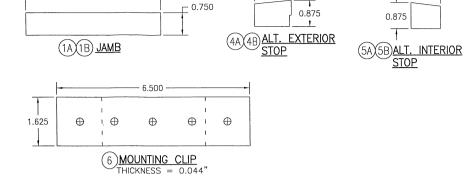

- 4.562 -

1.250

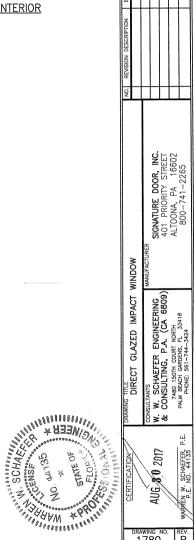

DRAWING NO.

1780 SHEET NO. 3 of

REV. B

CHECKED BY W.W.S.

DATE: 10/31/11

RAWN BY: W.R.M.

1.000