GENERAL

1. THIS PRODUCT HAS BEEN TESTED, ANALYZED & APPROVED FOR DESIGN PRESSURES NOT TO EXCEED THOSE SHOWN IN THE "ALLOWABLE DESIGN PRESSURE TABLE(S)".

2. OPENINGS, BUCKING & BUCKING FASTENERS MUST BE PROPERLY DESIGNED & INSTALLED TO TRANSFER WIND LOADS TO THE STRUCTURE.

3. ALL HARDWARE & FASTENERS SHALL BE IN ACCORDANCE WITH THESE DRAWINGS & SHALL NOT WARY UNLESS SPECIFICALLY MENTIONED ON THE DRAWINGS. SPECIFIED ANCHOR EMBED TO BASE MATERIAL SHALL BE BEYOND WALL FINISH OR STUCCO.

4. THIS PRODUCT HAS BEEN DESIGNED IN ACCORDANCE WITH AND MEETS THE REQUIREMENTS OF THE FLORIDA BUILDING CODE (FRD) FOR NON-HIGH VELOCITY HUBRICAME ZOMES (NON-HIVEZ).

5. THIS PRODUCT IS NON-HIPACT RATED & MUST BE SHUTTERED BUCKS OR WOOD FRAMING SHALL BE CAPABLE OF RESISTING CORROSION CAUSED BY THE PRESSURE TREATING CHEMICALS IN THE WOOD.

7. DETERMINE THE COMERNING CODE AND GOVERNING WIND VELOCITY. FOR WIND LOAD CALCULATIONS IN ACCORDANCE WITH THE COMERNING CODE. ADD GOVERNING WIND VELOCITY. FOR WIND LOAD CALCULATIONS IN ACCORDANCE WITH THE COMERNING CODE. ADD RECATIVE DESIGN LOADS TO USE WHEN REFERENCING THESE DRAWINGS IN ACCORDANCE WITH THE COMERNING CODE, A DIRECTIONALITY FACTOR OF Kd = 0.85 MAY BE APPLIED PER THE ASCET AT SYMADARD.

8. MATERIALS, INCLUDING BUT NOT LIMITED TO STEEL SCREWS, THAT COME INTO CONTACT WITH OTHER SUSMILLAR MATERIALS SHALL MEET THE REQUIREMENTS OF FLORIDA BUILDING CODE.

9. TO THE BEST OF OUR KNOWLEDGE, THE PRODUCT SHOWN HEREID SI QUALITY ASSURED BY A FLORIDA ALL SECONDANCES, THE MANUFACTURER'S QUALITY ASSURANCE SPECIFICATIONS & TESTING REPORTS.

10. CERTIFICATION OF THIS PRODUCT SHALL BE CONSIDERED WORD IF IT IS INSTALLED WITHOUT A BUILDING DEPARTMENT OR IF IT IS INSTALLED BY ANYONE OTHER THAN ADDITIONAL MALY'SIS. PRODUCT ASSENDLY SHALL BE IN ACCORDANCE WITH HEED OF ANYONE OTHER THAN ADDITIONAL MALY'SIS. PRODUCT ASSENDLY SHALL BE WAYONE OTHER THAN ASSURED ON THIS TYPE OF PRODUCT.

11. ALL WOOD MEMBERS OF THIS PRODUCT THAT MAY POSSIBLY COME INTO CONTACT WITH MASONRY OR THE THAN THAN THAN THAN THAN THAN THAN TH

REVIEW AND CERTIFICATION (EXAMPLE: SMALLER DOORS TO HIGHER ALLOWABLE DESIGN PRESSURE THAN WHAT

OVERHANG WHERE-BY THE OVER INFILTRATION OR THE UNITS ARE

	LOCK SYSTEM DESCRIPTIONS	CRIPTIONS
LOCK	DESCRIPTION	PTION
SYSTEM	ACTIVE PANEL	INACTIVE PANEL
٠.	LATCH & DEAD BOLT	TOP & BOTTOM
,,,,,,	ONLY	SHOOT BOLTS
)	3-POINT MULTI-POINT	TOP & BOTTOM
^	LOCK	SHOOT BOLTS
7	5-POINT MULTI-POINT	TOP & BOTTOM
د	LOCK	SHOOT BOLTS
	LATCH & TRU-LOCK	TOP & BOTTOM
4	MULTI-POINT PLUS	SHOOT BOLTS
	SURFACE BOLTS (1)	
,		

SURFACE BOLTS IN LOCK SYSTEM 4 ARE REQUIRED WITH SINGLE PANEL DOORS.

EVALUATION OF THIS PRODUCT IS BASED ON APPLICABLE STANDARDS AND/OI INFORMATION & RESULTS FROM APPLICABLE TEST REPORTS. THE FLORIDA BUILDING CODE VERSION CONSIDERED WITH THIS EVALUATION WAS THAT IN FORCE AT THE TIME OF THE EVALUATION. IN THE EVENT OF CODE VERSION CHANGES/UPDATES OR IN THE EVENT THAT NEW OR ADDITIONAL TESTING IS COMPLETED ON THIS PRODUCT, PRIOR TO STATING CODE COMPLIANCE WITH THE STATE, THE MANUFACTURER SHALL CONFIRM WITH THE EVALUATION ENGINEER OF RECORD THAT EVERYTHING SPECIFIED HERE—IN IS CURRENT WITH ALL CURRENT TESTING, CODES AND APPLICABLE STANDARDS. AND/OR

ROUND	2"	1 1/4"	(1) 3/16" CONCRETE SCREW	UMC
DOUBLE HALF	1/2"	FULL	NO. 10 GR. 5 SELF TAP/DRILL SCREW	T5 ALUM.
	1/2"	FULL	NO. 10 GR. 5 SELF TAP/DRILL SCREW	36 STEEL
	1/2"	FULL	NO. 10 GR. 5 SELF TAP/DRILL SCREW	METAL STUD
	3/4"	1 1/4"	NO. 10 SMS OR WOOD SCREW	E OR BUCK)=0.55)
			& STRIKE SCREWS	HINGE
SINGLE HALF SINGLE	2"	1 1/2"	(1) 1/4" CONCRETE SCREW	CRETE
	2"	1 1/4"	(1) 1/4" CONCRETE SCREW	MU
7	1/2"	FULL	NO. 10 GR. 5 SELF TAP/DRILL SCREW	-T5 ALUM.
	1/2"	FULL	NO. 10 GR. 5 SELF TAP/DRILL SCREW	36 STEEL
	1/2"	FULL	NO. 10 GR. 5 SELF TAP/DRILL SCREW	METAL STUD
PART OF	3/4"	1 1/4"	NO. 10 SMS OR WOOD SCREW	E OR BUCK ≔0.55)
SHAPES	MINIMUM EDGE DIST.	MINIMUM EMBED	FRAME TO OPENING FASTENER TYPE	PE E)
QUARTER ROUN			FRAME SCREWS	
SINGLE HALF-R			FRAME ANCHOR REQUIREMENTS TABLE	FRAME ANCH
(1) 3 HINGES F				
TALLER THAN 6'				
6'-8"		דרג	HE OVERHANG(OH) RAIIO IS EQUAL IO OR MORE IHAN I.O PER	HE OVEKHANG(OH
DOOR HEIGHT		OPY OR	ITS ARE INSTALLED AT LOCATIONS PROTECTED BY A CANOPY OR	VITS ARE INSTALLI
HINGE RE		WATER	WHERE THE UNIT & THE AREA ARE DESIGNED TO ACCEPT WATER	WHERE THE UNIT

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RECTANGULAR

SINGLE QUARTER ROUND

CONSIDERED

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WOOD FRAME OR BU

OPENING TYPE

(SUBSTRATE)

GR. 3 & G=0.55)

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33

KSI METAL

MIN. 1/8" THK 6063-T5 ALU

/8" THK A36 STEEL

2500

Sq

CONCRETE

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C-90 CMU

GE REQUIREMENTS NGES REQUIRED WITH ALL OF DOUBLE HALF ROUND, & SINGLE HAN 6'-8" HEIGHT ROUND DOORS # HINGES Ξ 4 Ś REQ'D

STATED ABOVE.

SASH SET SASH CORNERS: RAILS ARE SQUARE CUT, BUTTED TO THE STILES, JOINED TO SASH SET SASH CORNERS: TAILS ARE SQUARE CUT, BUTTED TO THE STILE WITH ONE(1) 5/8" X 3" DOWEL AND FULLY GLUED WITH KORLOCK GT-42-300A OR WATERPROOF'S TITEBOND III GLUE (DOWEL AND MEETING SURFACES).

DOOR CORNER CONSTRUCTION: HEAD FRAME CORNERS: OPTION 1: SIDE JAMB MEMBER

PLO1: 1=24

BY:

MEMBER IS SQUARE CUT, BUTTED TO THE SIDE JAMB MEMBER, FULLY BONDED/SEALED WITH DOW 995 OR BOSS/QUANEX GS1 SEALANT AND JOINED WITH THREE(3) 1/2" x 2" LONG 16 GAGE CROWN STAPLES. OPTION 2: JAMBS END IS COPED, BUTTED TO THE HEAD, FULLY BONDED/SEALED WITH DOW 995 OR BOSS/QUANEX GS1 SEALANT AND JOINED WITH 3 NO. 10 x 3" SCREWS.

SILL MEMBER IS SQUARE CUT, BUTTED TO THE SIDE JAMB MEMBER IS COPED. SILL MEMBER IS SQUARE CUT, BUTTED TO THE SIDE JAMB MEMBER, FULLY BONDED/SEALED WITH DOW 995 OR BOSS/QUANEX GS1 SEALANT AND JOINED WITH TWO(2) NO. 10 X 2" LONG WOOD OR SMS SCREWS. OPTION 2: JAMB END IS COPED, BUTTED TO THE SIILL, FULLY BONDED/SEALED WITH DOW 995 OR BOSS/QUANEX 6S1 SEALANT AND JOINED WITH 3 NO. 10 X 3" SCREWS. X 3" SCREWS.

SILL CORNERS (ADA SILL): JAMB IS CUT TO FIT, BUTTED TO SILL, FULLY BONDED/SEALED WITH DOW 995 OR BOSS/QUANEX GS1 SEALANT AND JOINED WITH 3 NO. 10 X 2" SCREWS.

MULLION JAMBS TO CONTINUOUS HEAD AND SILL: EACH JAMBS END IS COPED, BUTTED TO THE HEAD/SIILL, FULLY BONDED/SEALED WITH DOW 995 OR BOSS/QUANEX GS1 SEALANT AND JOINED WITH 3 NO. 10 X 3" SCREWS.

SEALANT AND JOINED WITH 3 NO. 10 X 3" SCREWS.

SEALANT AND JOINED WITH 3 NO. 10 X 3" SCREWS.

SEALANT AND JOINED WITH 3 NO. 10 X 3" SCREWS.

SEALANT AND JOINED WITH 3 NO. 10 X 3" SCREWS.

SEALANT AND JOINED WITH 3 NO. 10 X 3" SCREWS.

SEALANT AND JOINED WITH 5 NO. 10 X 3" SCREWS.

SEALANT AND JOINED WITH 5 NO. 10 X 3" SCREWS.

SEALANT AND JOINED WITH 5 NO. 10 X 3" SCREWS.

SEALANT AND JOINED WITH 5 NO. 6 X 1 1/8" AND 8 NO. 6 X 1

WATERPROOF'S TITEBOND III GLUE AND JOINED WITH 8 NO. 6 X 1 1/8" AND 8 NO. 6 X 5/8" SMS SCREWS.

Y 5/8" SMS SCREWS.

TOP RAIL TO STILE: RAIL IS SQUARE CUT, BUTTED TO THE STILE, JOINED TO THE STILE WITH TWO(2) 5/8" X 3" DOWELS AND FULLY GLUED WITH KORLOCK GT-42-300A OR WATERPROOF'S TITEBOND III GLUE (DOWELS AND MEETING SURFACES).

STANDARD BOTTOM RAIL TO STILE: RAIL IS SQUARE CUT, BUTTED TO THE STILE, JQINED TO THE STILE WITH THREE(3) 5/8" X 3" DOWELS AND FULLY GLUED WITH KORLOCK GT-42-300A OR WATERPROOF'S TITEBOND III GLUE (DOWELS AND MEETING SURFACES).

BOTTOM RAIL TO STILE WHEN TOP RAIL IS FULL RADIUS: EACH THE RAIL END AND STILE EDGE ARE GROOVED TO ACCEPT A 1/2" THICK X 3 3/8" WIDE X 7 7/16" LONG HARDWOOD KEY. ONCE JOINED VIA THE KEY, ALL SURFACES ARE GLUED WITH KORLOCK THE BOOK III GLUE (DOWELS ARE GLUED WITH KORLOCK THE BOOK).

GT-42-300A OR WATERPROOF'S TITEBOND III GLUE.

MID-RAIL TO STILE: RAIL IS SQUARE CUT, BUTTED TO THE STILE, JOINED TO THE STILE WITH TWO(2) 5/8" X 3" DOWELS AND FULLY GLUED WITH KORLOCK GT-42-300A OR WATERPROOF'S TITEBOND III GLUE (DOWELS AND MEETING SURFACES).

MID-STILE TO RAIL: STILE IS SQUARE CUT, BUTTED TO THE RAIL, JOINED TO THE RAIL WITH TWO(2) 5/8" X 3" DOWELS AND FULLY GLUED WITH KORLOCK GT-42-300A OR WATERPROOF'S TITEBOND III GLUE (DOWELS AND MEETING SURFACES).

FULL RADIUS STILE/RAIL JOINERY AT RADIUS END: RAIL & STILE ARE VERTICALLY CUT, BUTTED TOGETHER, JOINED WITH TWO(2) 5/8" X 3" DOWELS AND FULLY GLUED WITH KORLOCK GT-42-300A OR WATERPROOF'S TITEBOND III GLUE (DOWELS AND MEETING WITH TWO(2) 5/8" X 3" DOWELS AND FULLY GLUED WITH KORLOCK GT-42-300A OR WATERPROOF'S TITEBOND III GLUE (DOWELS AND MEETING KORLOCK GT-42-300A SURFACES).

TRANSOM CORNER CONSTRU

AND SASH SET TRANSOM SAME AS DOOR "HEAD FRAME CORNERS"

THESE DRAWINGS ARE APPLICABLE ONLY TO THE PRODUCT SPECIFIED. THEY MAY NOT BE USED FOR THE ASSEMBLY AND/OR INSTALLATION OF ANY OTHER PRODUCT NOR MAY THEY BE USED FOR RATIONAL AND/OR LOCAL APPROVAL OF ANY PRODUCT NOT PRODUCED BY THE MANUFACTURES STATED ON THESE DRAWINGS. MAY

RAMSET/RED

SCREWS

HEAD

TAPCONS (C.S. SHALL

C.S. OR S.S.) OR

(C.S.),

), ELCO CRETE-FLEX KWIK-CON II (C.S OI

SR. (S.S.) R S.S. 2500

PSI CONCRETE

(1) 3/16" CONCRETE SCREW

1 1/4 1 1/2" W

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NOTE:

EYEBROW

T P

DOORS

SHALL

38

EYEBROW DOUBLE

RECTANGULAR DOUBLE

INSTALLED THE

SAME AS RECTANGULAR.

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SA.

33 KSI METAL ST

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THK A36

WOOD

FRAME OR

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& G=0.55)

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/8" THK 6063-T5 ALU

C-90

CMC

SHEET NO. 899 읶 တ \bigcirc

8 FT. NON-IMPACT OUT-SWING WOOD DOORS CONSULTANTS W. W. SCHAEFER ENGINEERING & CONSULTING, P.A.

MANUFACTURER

BY REVISION DESCRIPTION NO. w.w.s. ADDED THRESHOLD OPTIONS W.W.S w.w.s 82 ADDED WEATHERSEAL OPTION JPDATE PER NEW TESTING W.W.S. 814-949-2770

SCHAEFER, NO. 44135 WARREN W. P.E.


CERTIFICATION

DRAWING TITLE

26376 NADIR ROAD; UNIT 309 PUNTA GORDA, FL 33983 PHONE: 561-744-3424

SIGNATURE DOOR INC. 401 PRIORITY STREET ALTOONA, PA 16602

DATE 08/04/17 08/05/20 08/05/20 11/27/23

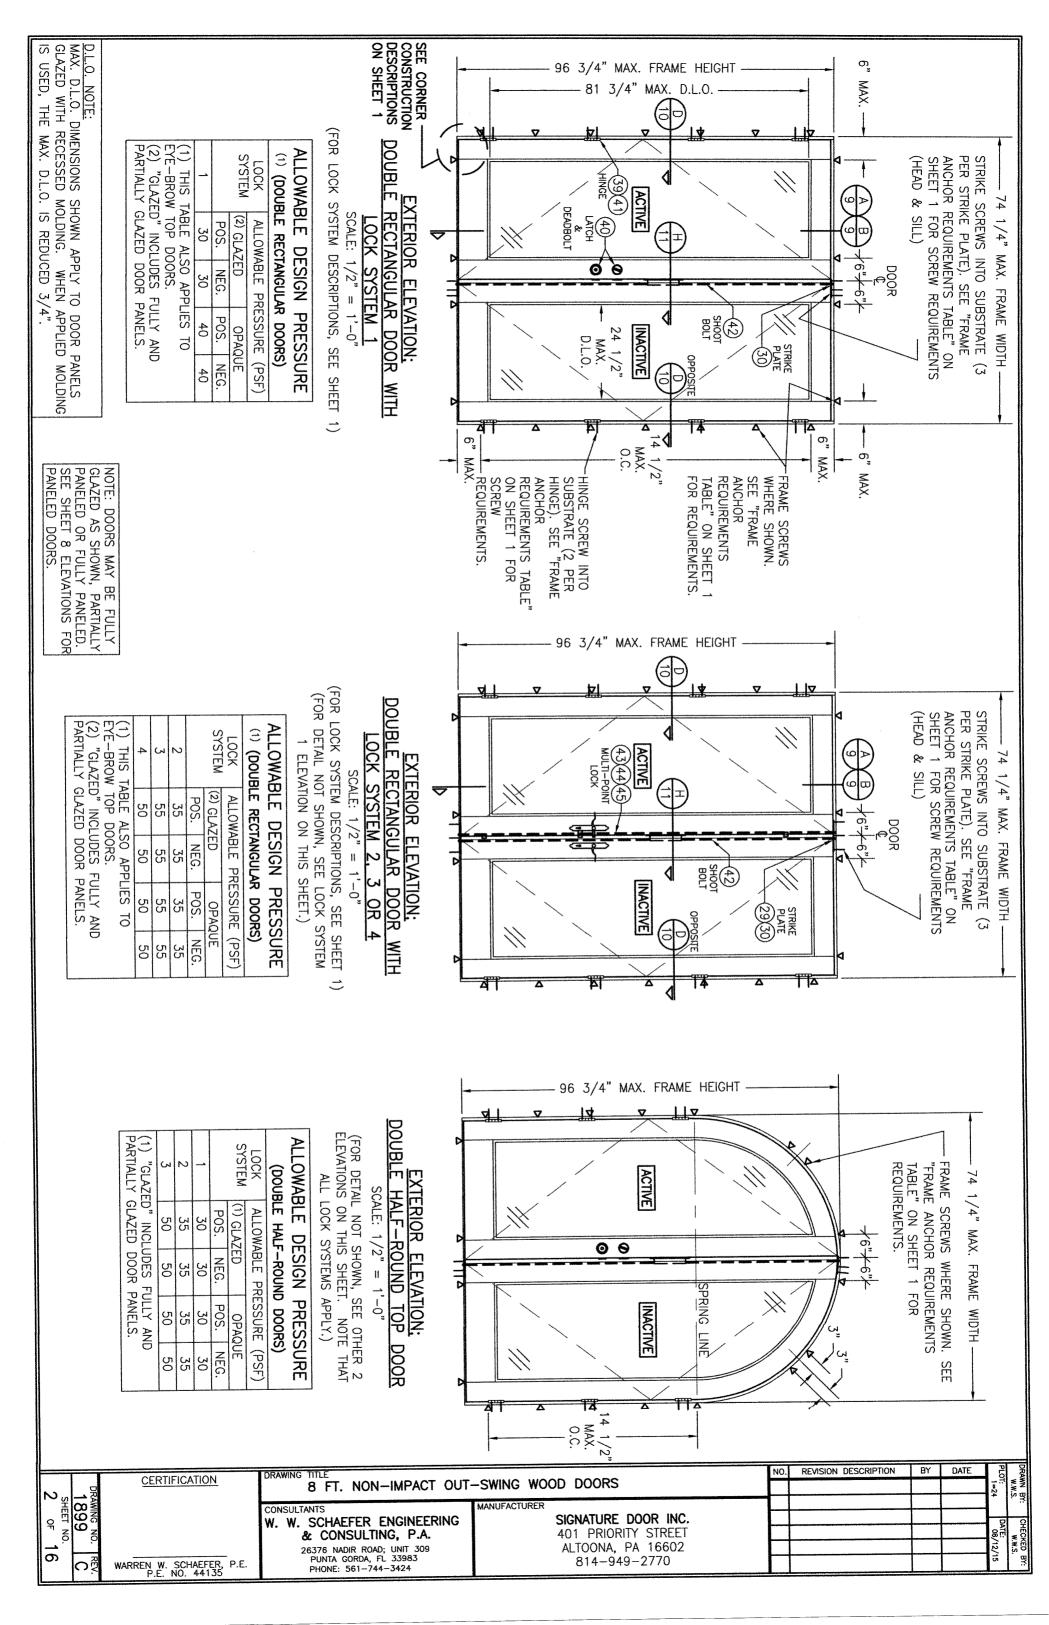

USED, THE MAX. D.L.O. IS REDUCED WHEN APPLIED MOLDING 3/4".

D.L.O. NOTE:

MAX. D.L.O. DIMENSIONS SHOWN APPLY TO DOOR PANELS
GLAZED WITH RECESSED MOLDING. WHEN APPLIED MOLDI

NOTE: DOORS MAY BE FULLY GLAZED AS SHOWN, PARTIALLY PANELED OR FULLY PANELED. SEE SHEET 8 ELEVATIONS FOR

(2) "GLAZED" INCLUDES GLAZED DOOR PANELS.

FULLY AND PARTIALLY

OP DOORS.

THIS TABLE ALSO APPLIES

7

EYE-BROW

43

50 55 30

50 50 55

5 5


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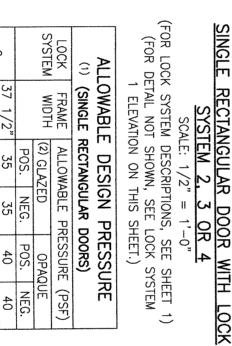
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30


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37 1/2






EXTERIOR ELEVATION;

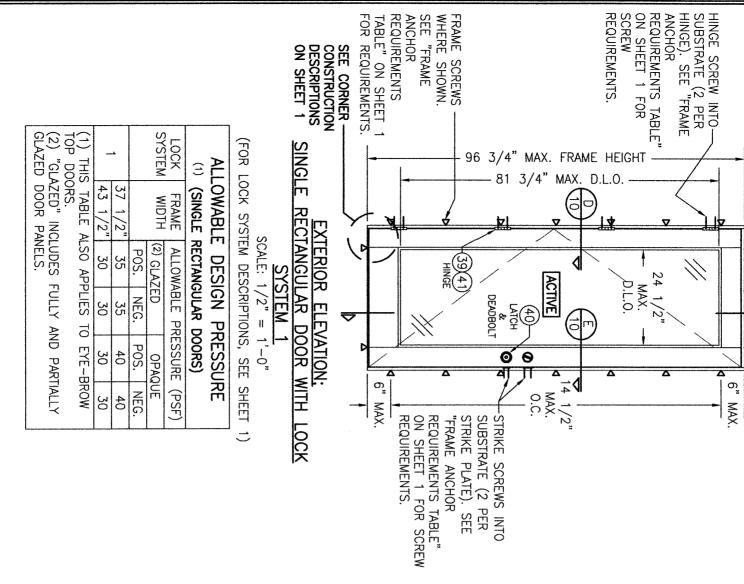

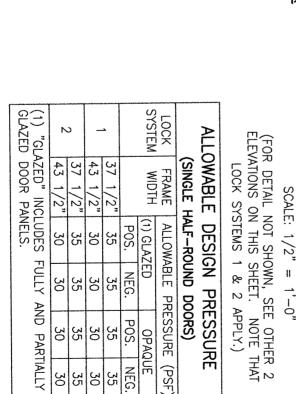NEG.

30

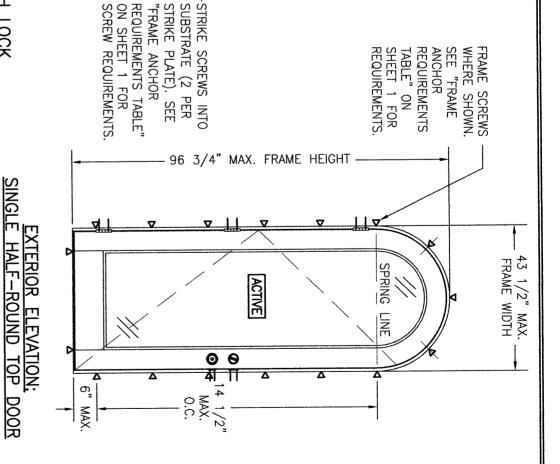

96 3/4" MAX. FRAME HEIGHT

ACTIVE

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MAX.

ರ್ತಾ

MAX.

FRAME WIDTH

43 1/2" MAX. FRAME WIDTH

ORAN ST ORAN	CERTIFICATION	DRAWING TITLE 8 FT. NON-IMPACT OUT		NO.	REVISION DESCRIPTION	BY	DATE	PLOT: 1=24	DRAWN BY: W.W.S.
MNG NO. REV. 899 C HEET NO. OF 16	WARREN W. SCHAEFER, P.E. P.E. NO. 44135	CONSULTANTS W. W. SCHAEFER ENGINEERING & CONSULTING, P.A. 26376 NADIR ROAD; UNIT 309 PUNTA GORDA, FL 33983 PHONE: 561-744-3424	MANUFACTURER SIGNATURE DOOR INC. 401 PRIORITY STREET ALTOONA, PA 16602 814-949-2770					L	CHECKED BY: W.W.S.

D.L.O. NOTE:
MAX. D.L.O. DIMENSIONS SHOWN APPLY TO DOOR PANELS
GLAZED WITH RECESSED MOLDING. WHEN APPLIED MOLDING
IS USED, THE MAX. D.L.O. IS REDUCED 3/4".

(1) "GLAZED" INCLUDES FULLY AND PARTIALLY GLAZED DOOR PANELS. 50 50 50

ALLOWABLE DESIGN PRESSURE SYSTEM LOCK LOCK (SINGLE QUARTER—ROUND DOORS) SCALE: 1/2" = 1'-0"(1) GLAZED ALLOWABLE PRESSURE (PSF) POS. SYSTEMS APPLY.) 35 30 NEG. 35 30 POS. 35 30 OPAQUE NEG. 50 30

SINGLE (FOR DETAIL NOT SHOWN, SEE ELEVATIONS ON SHEET 3. NOTE THAT ALL LOCK EXTERIOR ELEVATION: QUARTER-ROUND TOP DOOR

6" MAX.

Δ

Δ

96 3/4" MAX. FRAME HEIGHT 81 3/4" MAX. D.L.O. EXTERIOR ELEVATION: RECTANGULAR ACTIVE SCALE: 1/2" = 1'-0"37 1/2" MAX. FRAME WIDTH 139(41) 29 1/2 ACTIVE D.L.O. MULTI-POINT LOCK (<u>a</u> Δ Δ SIDELITE REQUIREMENTS TABLE"
ON SHEET 1 FOR
SCREW REQUIREMENTS. SUBSTRATE (2 PER STRIKE PLATE). SEE "FRAME ANCHOR OPTION "A" ONLY!! STRIKE SCREWS INTO

REQUIREMENTS
TABLE" ON —
SHEET 1 FOR

SPRING LINE

Δ

ANCHOR

REQUIREMENTS.

ACTIVE

Δ

96 3/4" MAX. FRAME HEIGHT

9 0 वा

O.C.

2

FRAME SCREWS-WHERE SHOWN. SEE "FRAME

Δ

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57 1/2" MAX. FRAME WIDTH

6" MAX.

(ONLY RECTANGULAR SHAPE & LOCK SYSTEM 2 APPLIES TO THIS SIDELITE) ALLOWABLE DESIGN PRESSURE

(FOR INSTALLATION DETAIL NOT SHOWN,


SEE

ELEVATION ON SHEET 3.

(SINGLE RECTANGULAR ACTIVE SIDELITE) +45/-45 PSF

NOTE: DOORS MAY BE FULLY GLAZED AS SHOWN, PARTIALLY PANELED OR FULLY PANELED. SEE SHEET 8 ELEVATIONS FOR PANELED DOORS.

CERTIFICATIO	N DRAWING TITLE 8 FT. NON-IMPACT OUT-SWING WOOD DOO	RS NO.	REVISION DESCRIPTION	BY	DATE	PLOT:	DRAWN W.W
RAWING NO. REV. WARREN W. SCHAEF NO. P.E. NO. 44	& CONSULTING, P.A. 401 PR 26376 NADIR ROAD; UNIT 309 ALTOON	RIORITY STREET NA, PA 16602 -949-2770				DATE: 24 08/12/15	BY: CHECKED BY: S. W.W.S.

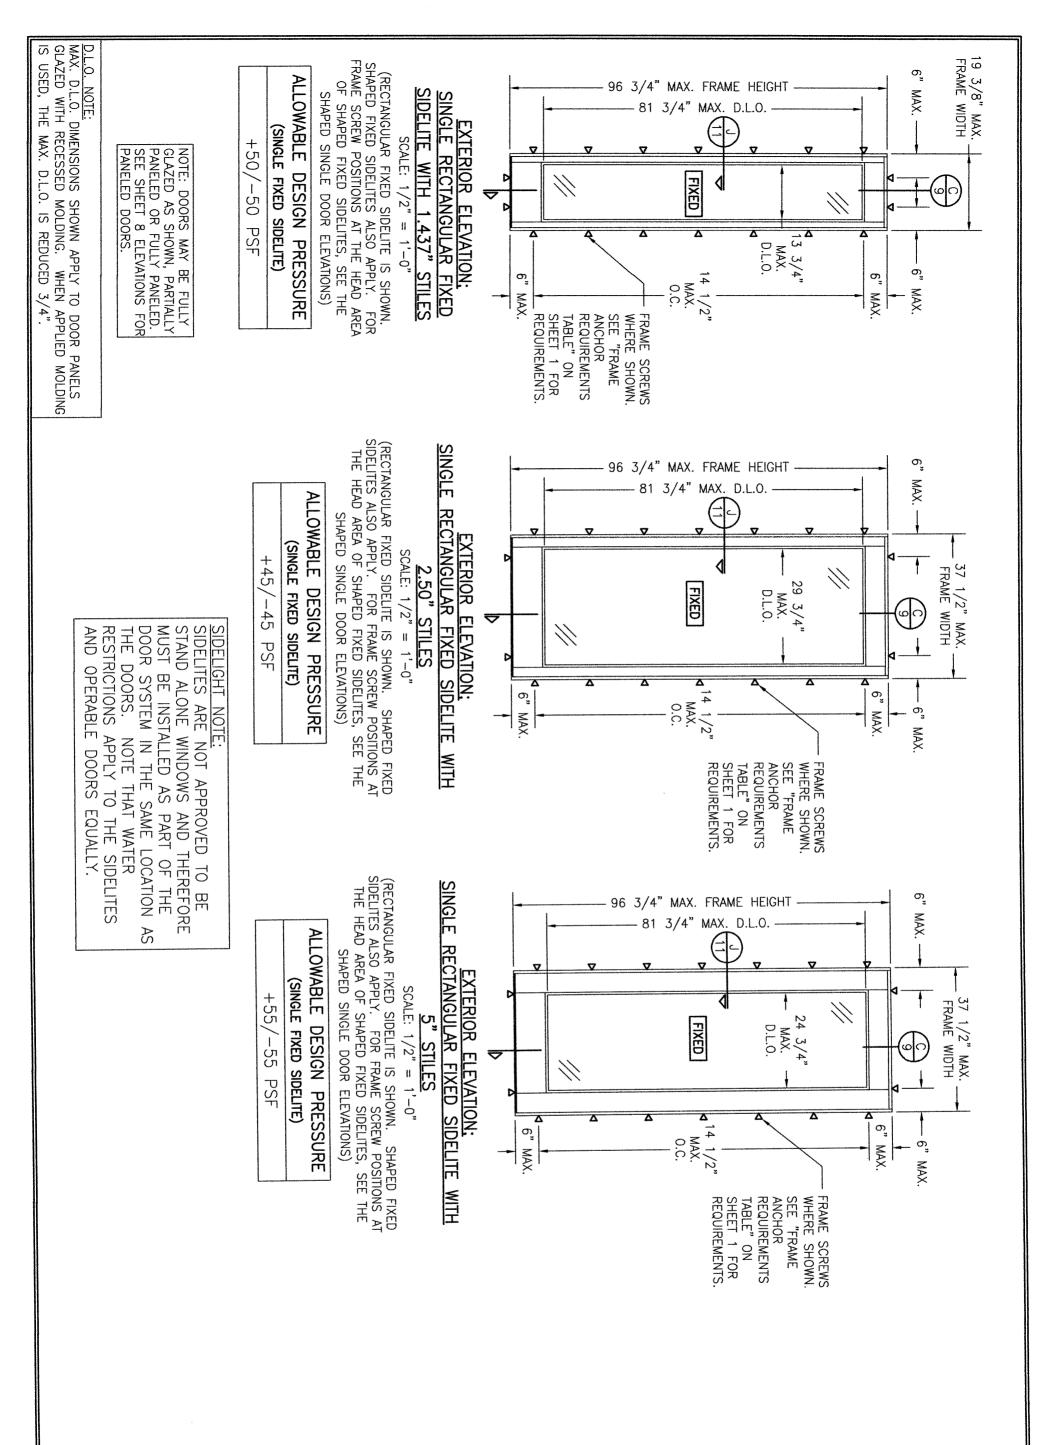

DRAWING TITLE

W. W. SCHAEFER ENGINEERING

& CONSULTING, P.A.

26376 NADIR ROAD; UNIT 309

PUNTA GORDA, FL 33983 PHONE: 561-744-3424

8 FT. NON-IMPACT OUT-SWING WOOD DOORS

MANUFACTURER

SIGNATURE DOOR INC.

401 PRIORITY STREET

ALTOONA, PA 16602

814-949-2770

CERTIFICATION

WARREN W. SCHAEFER, P.E. P.E. NO. 44135

1899 SHEET NO.

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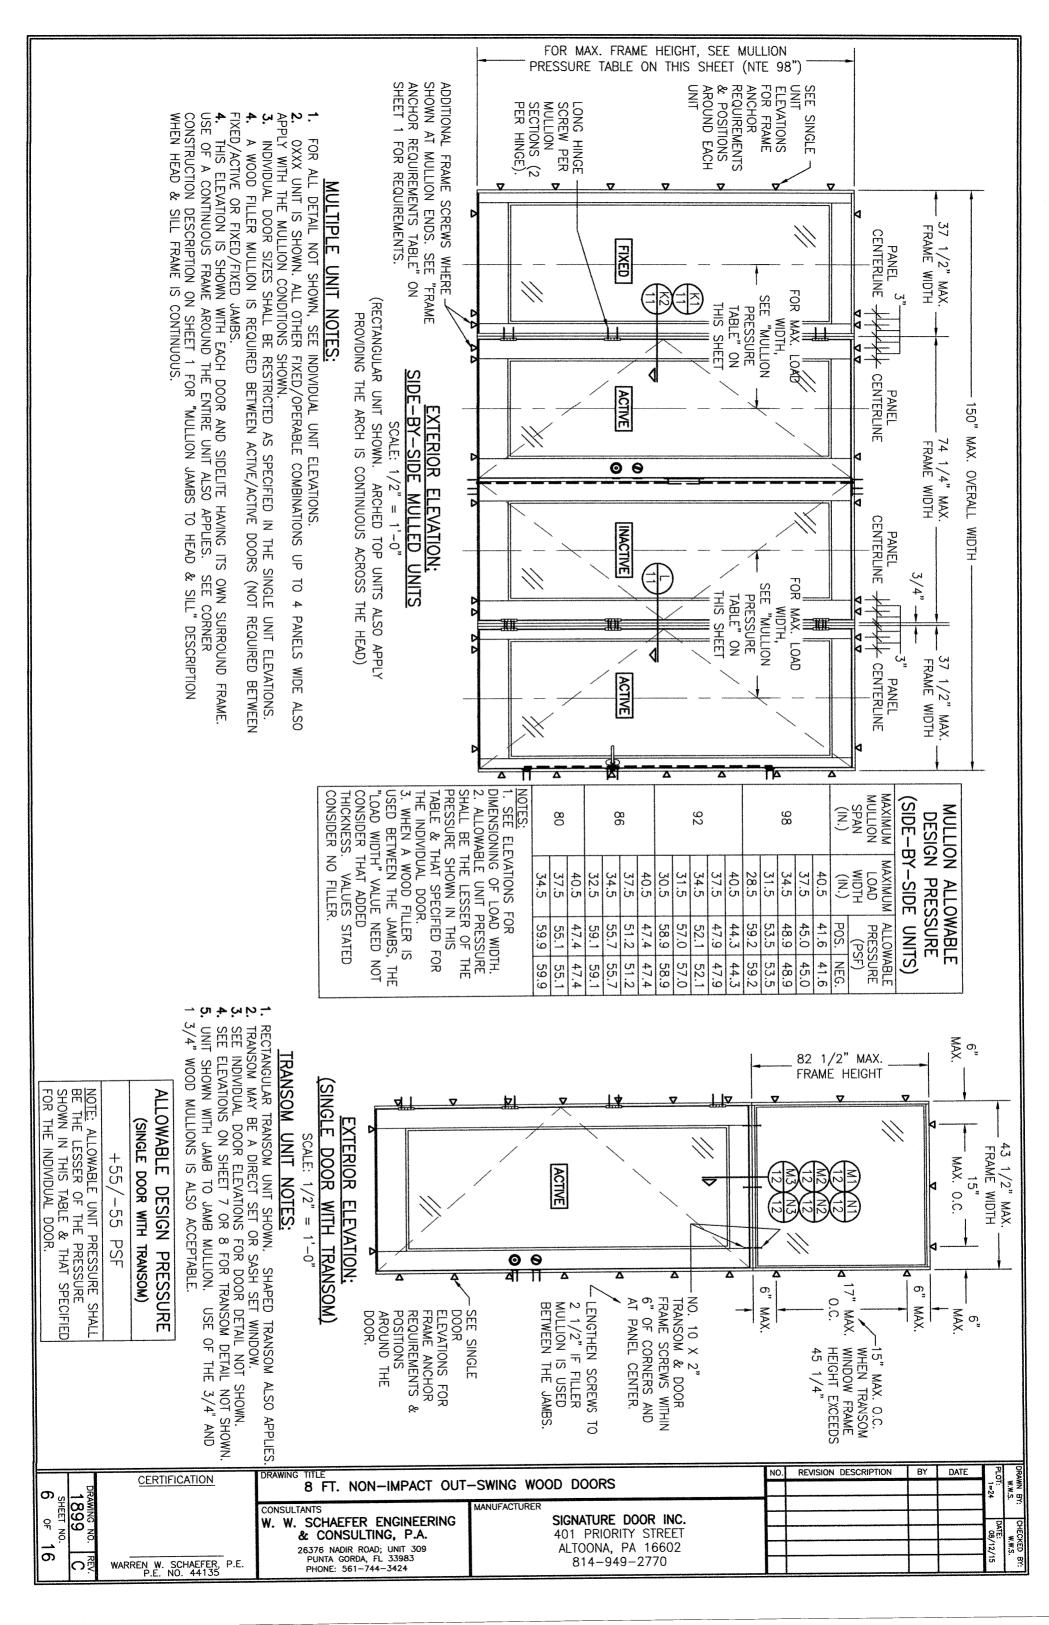
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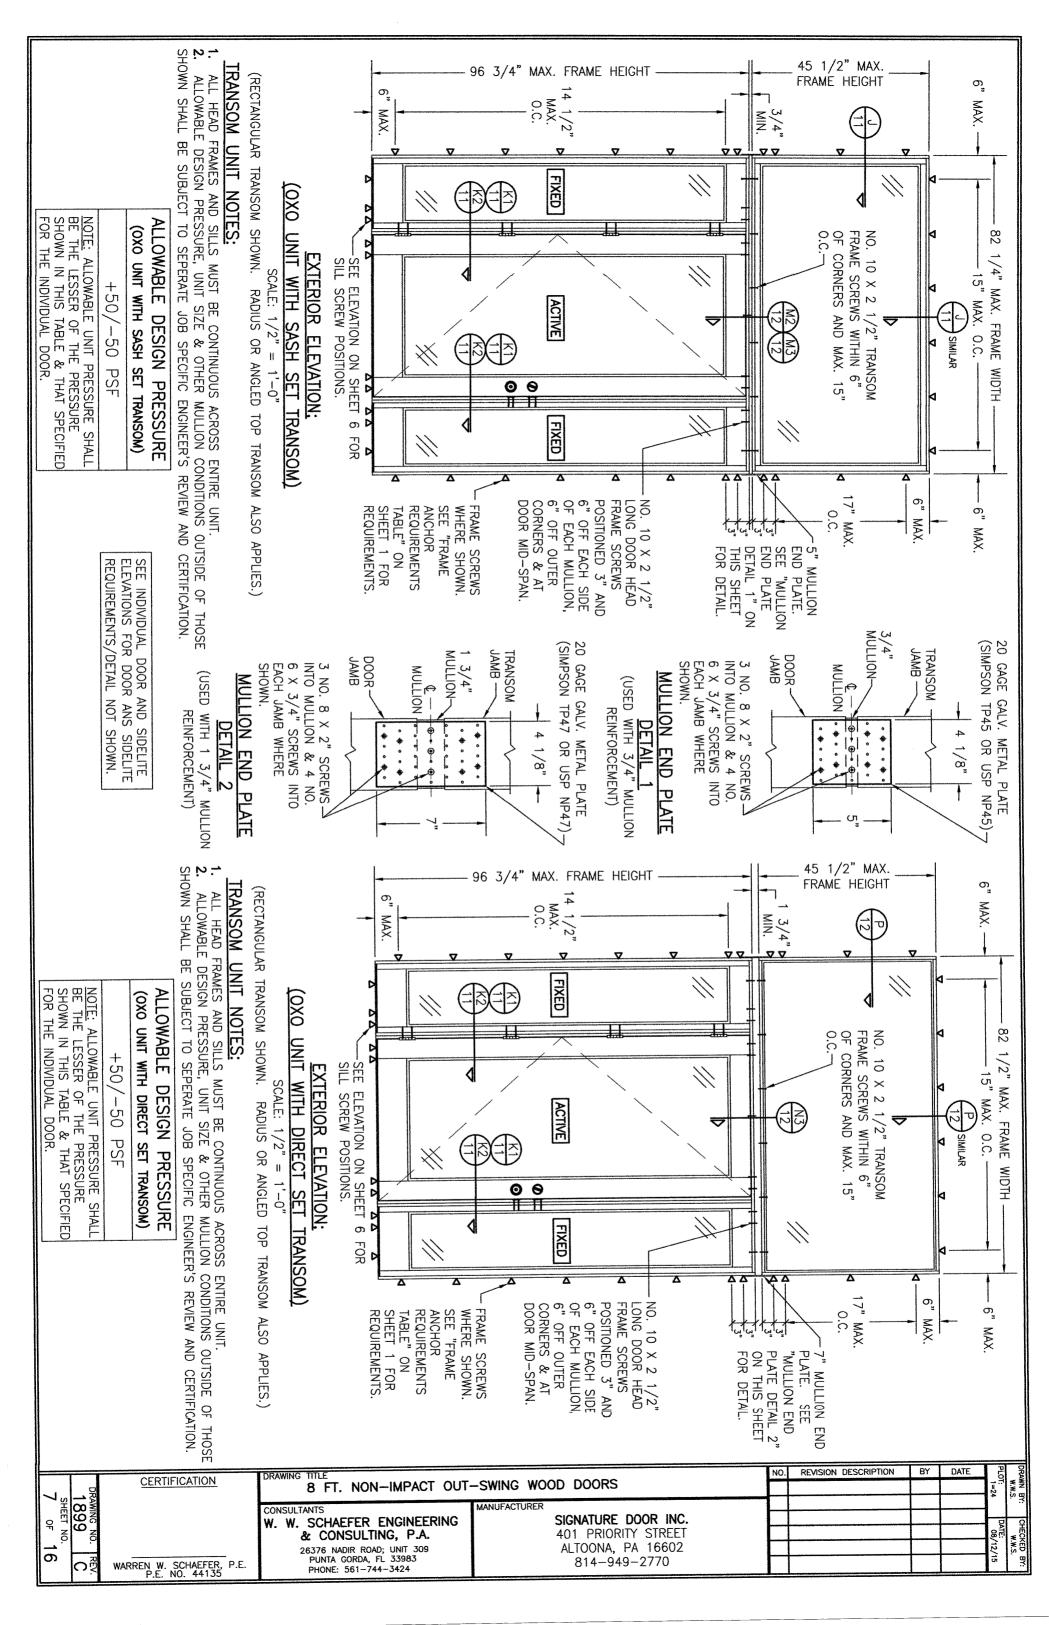
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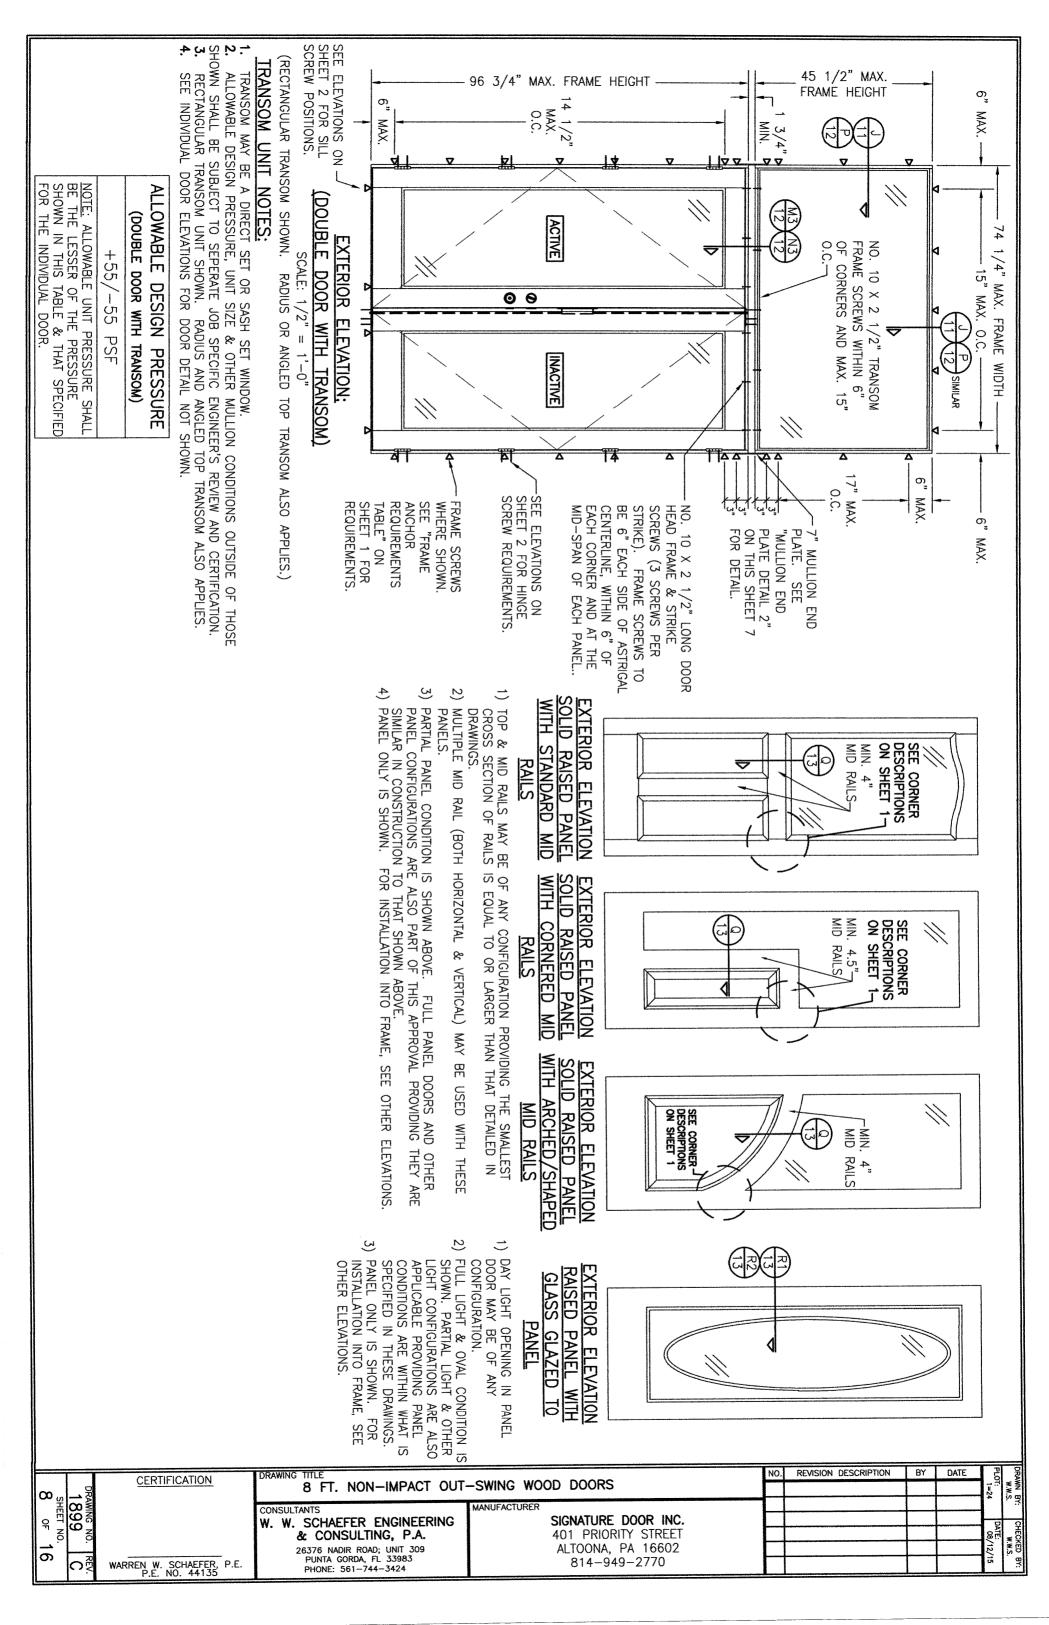
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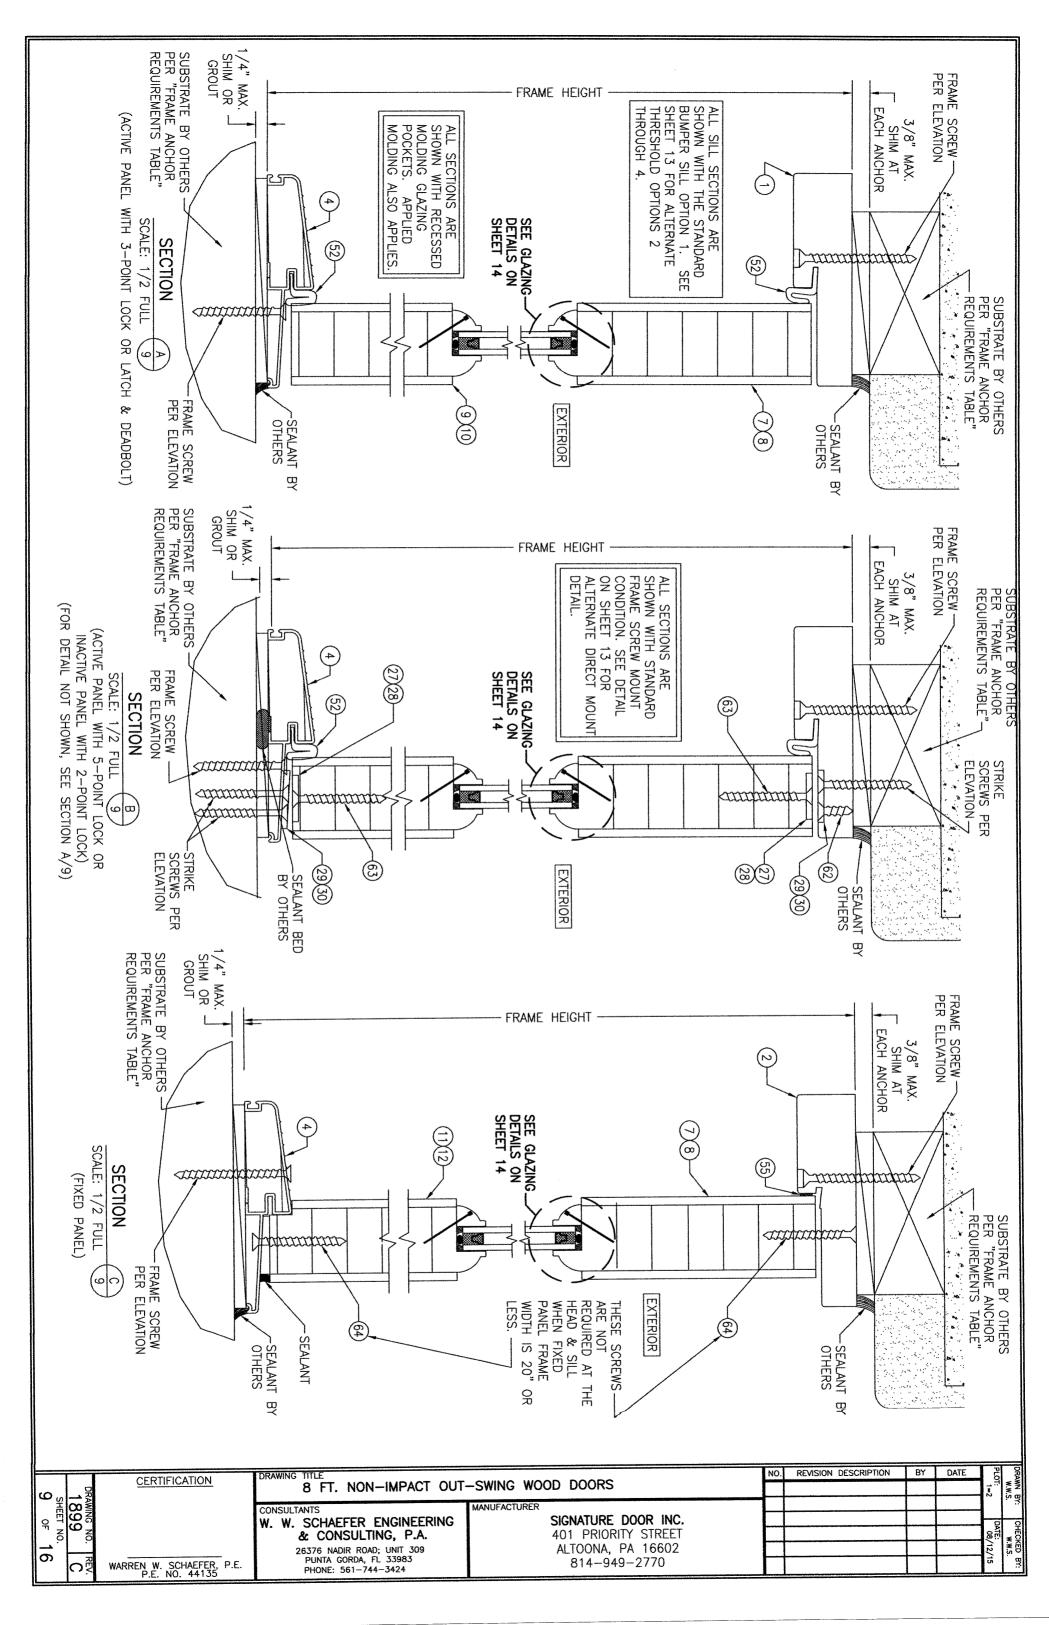
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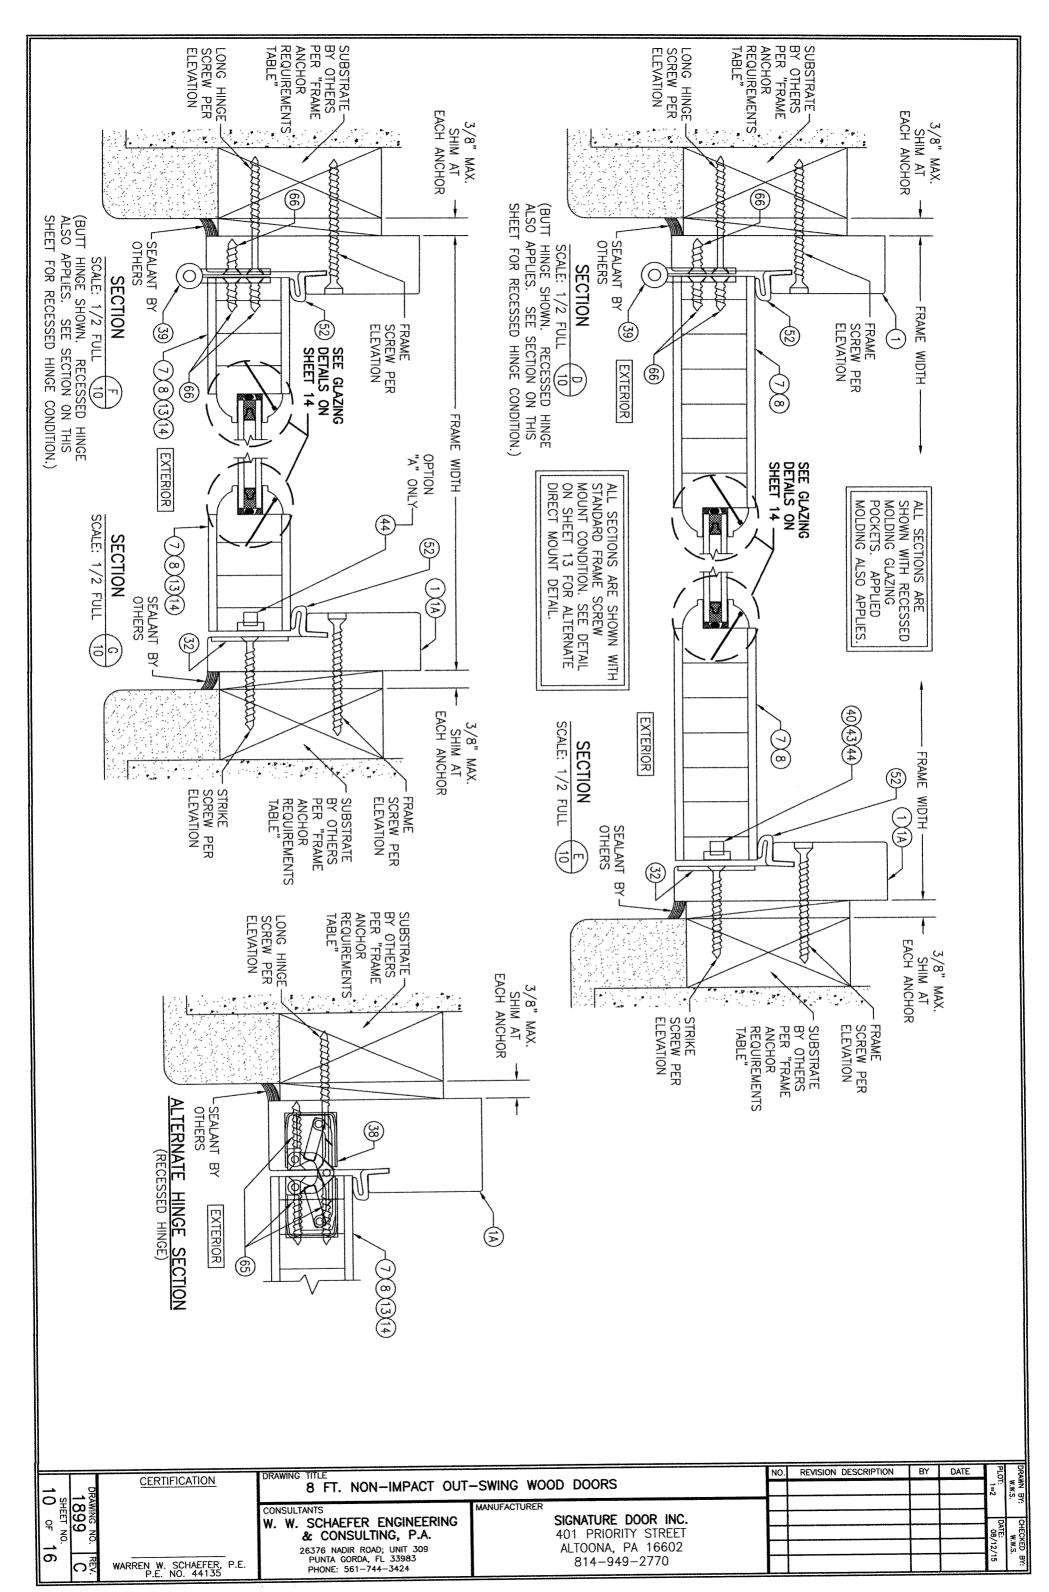
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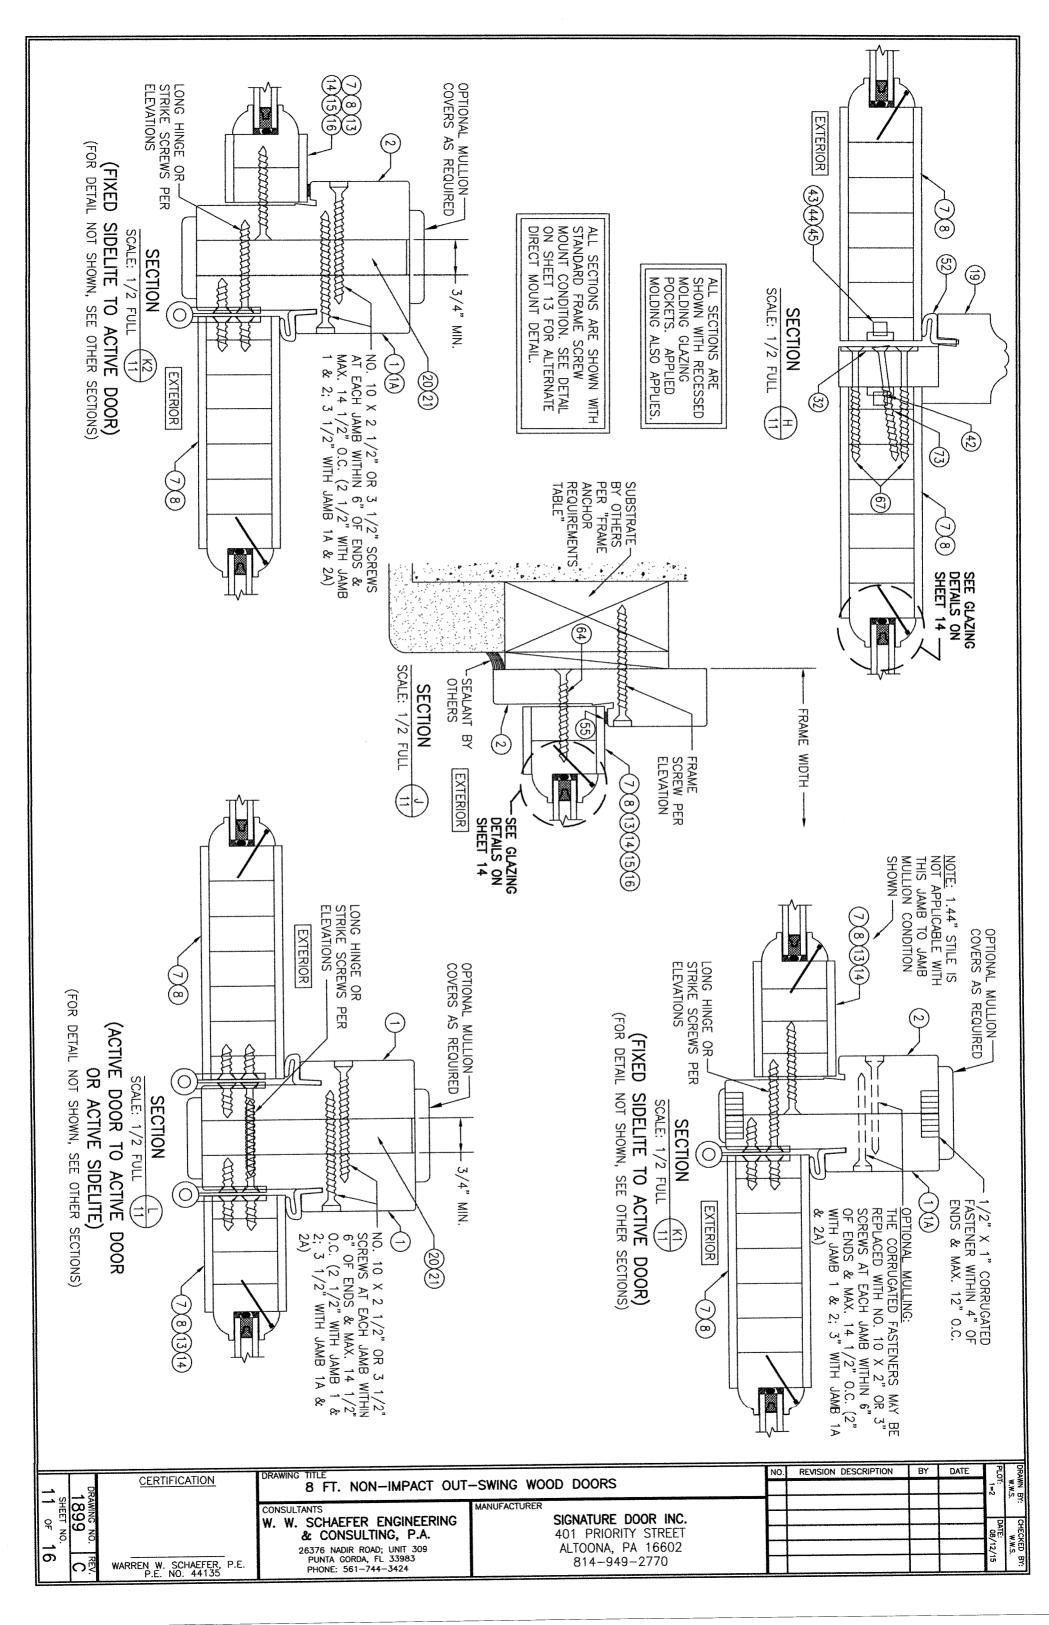
















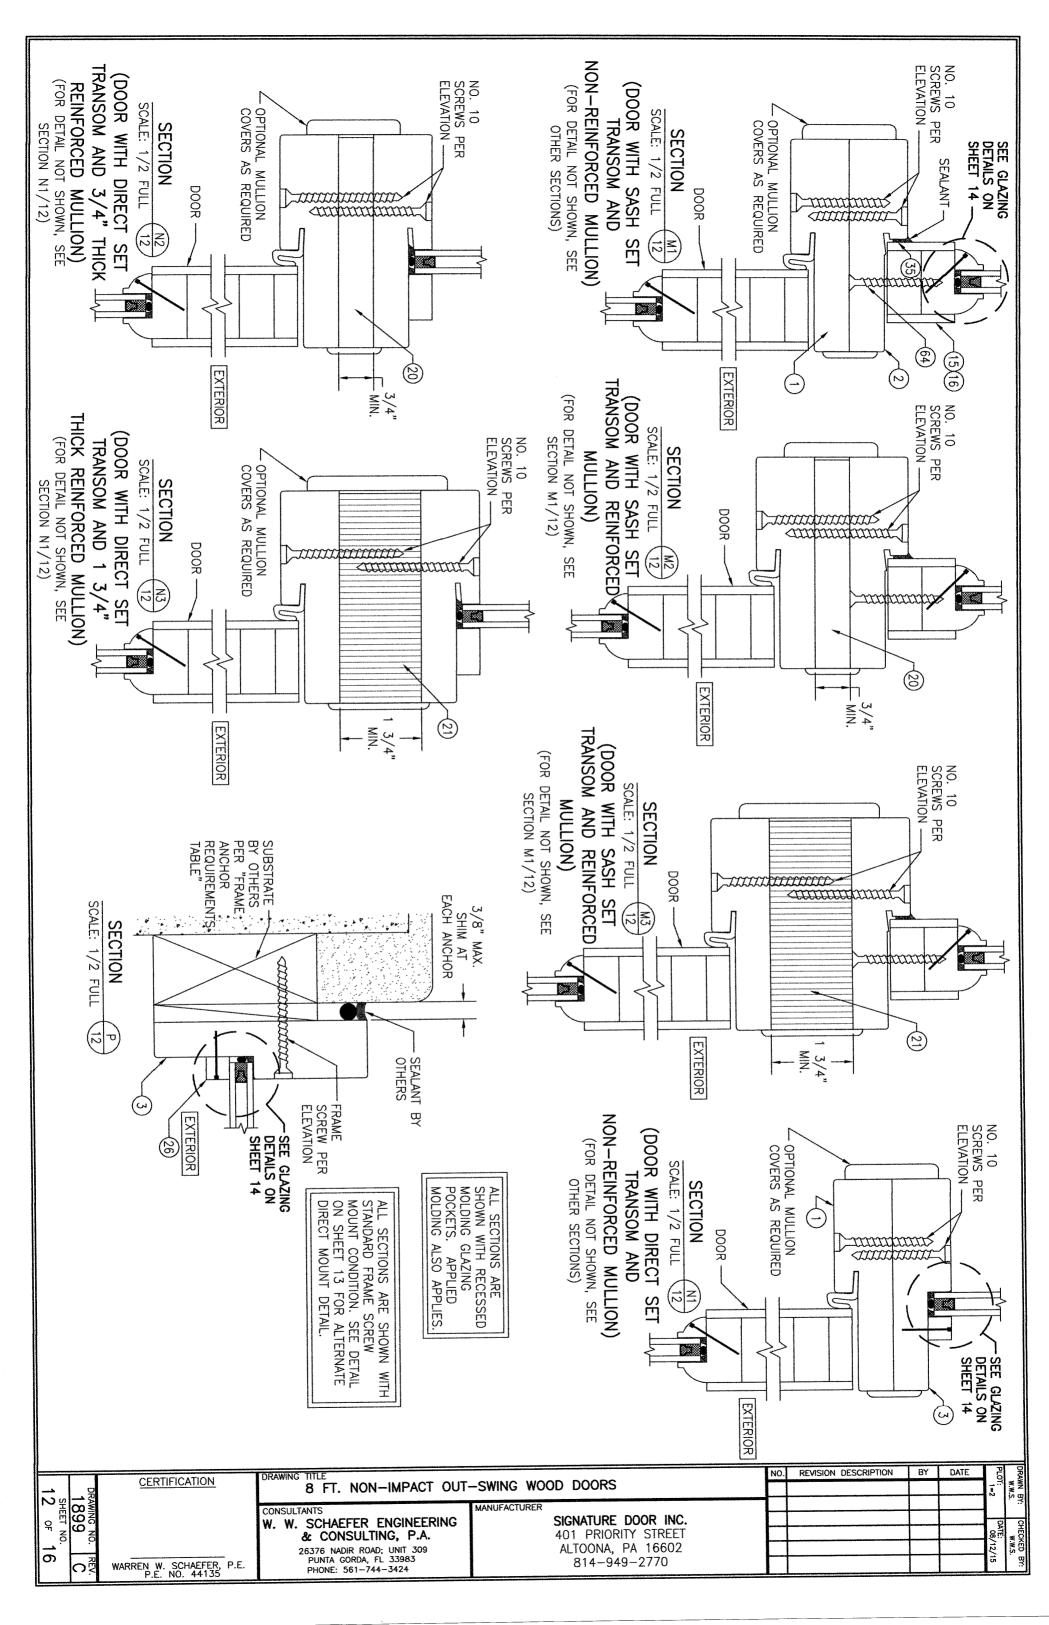

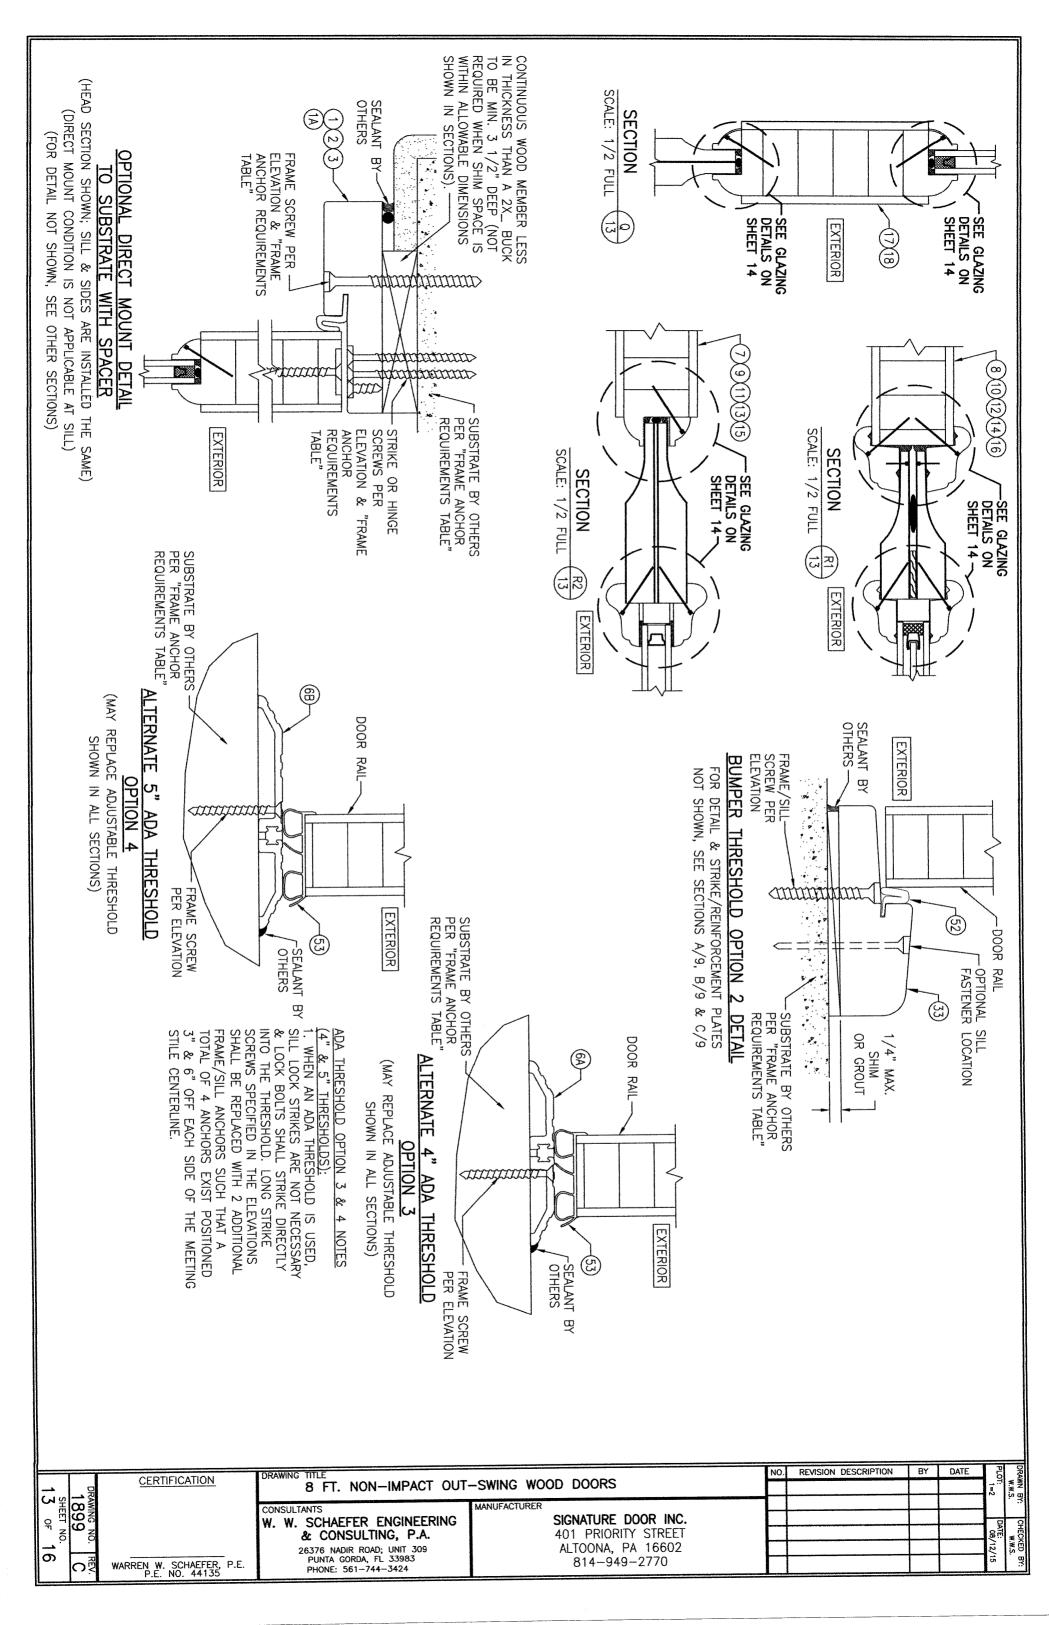

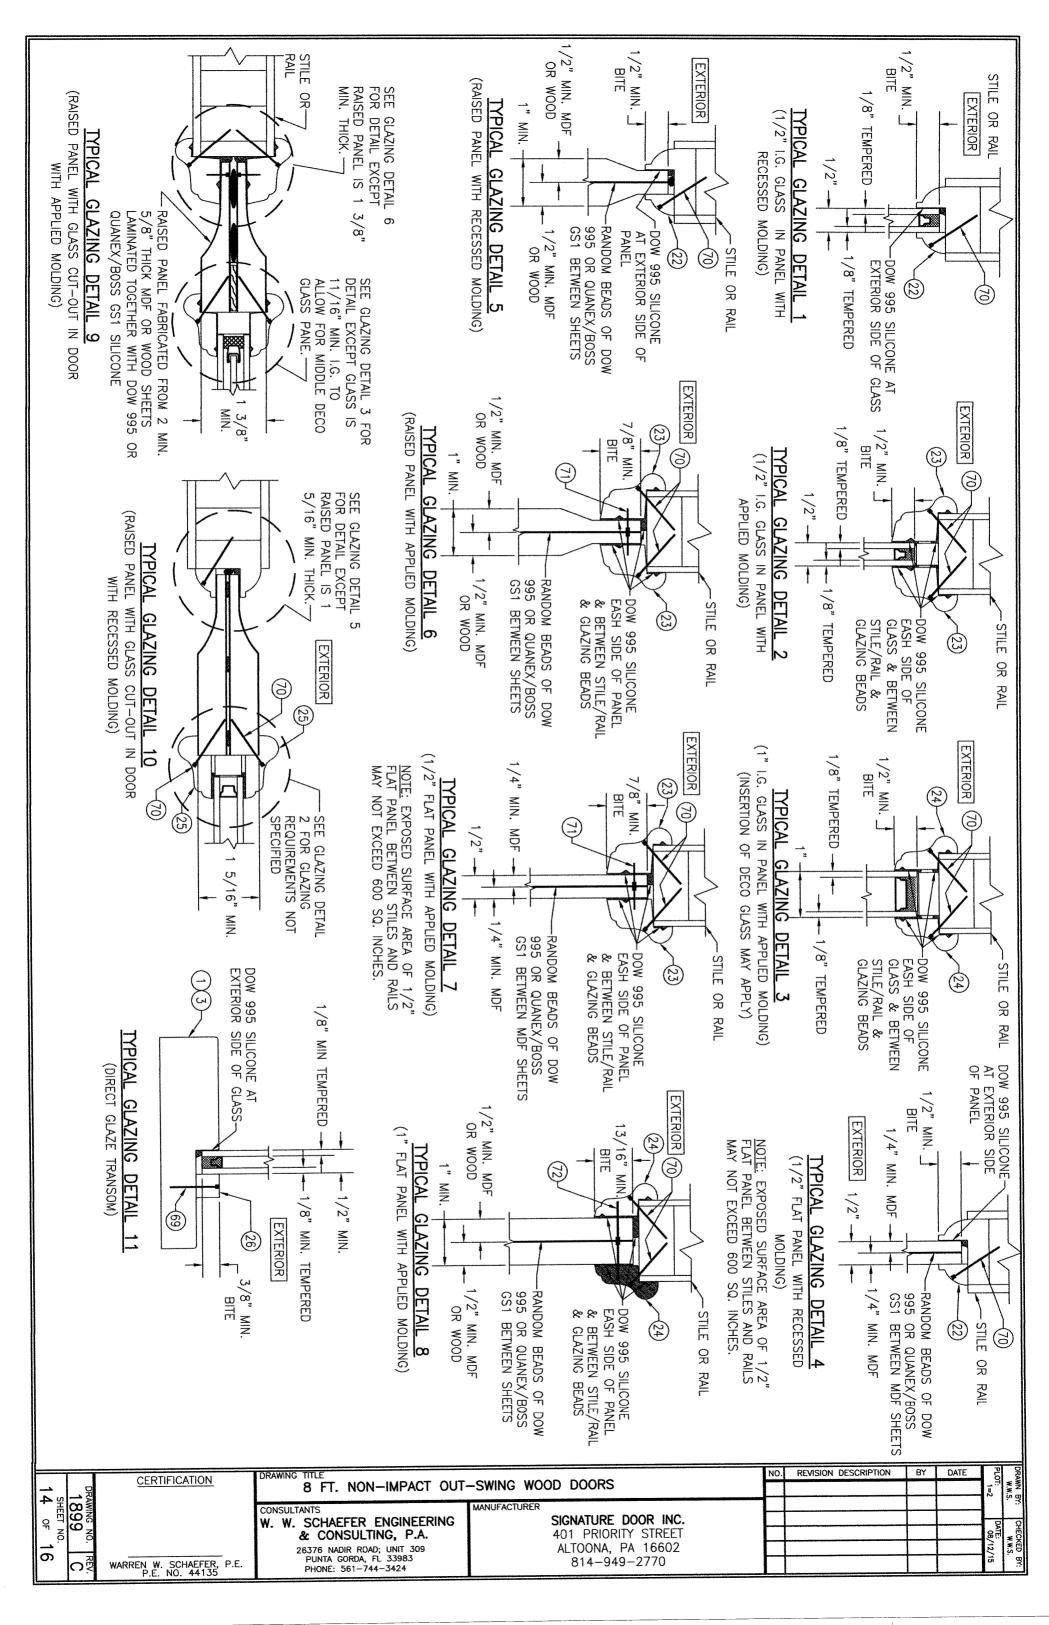

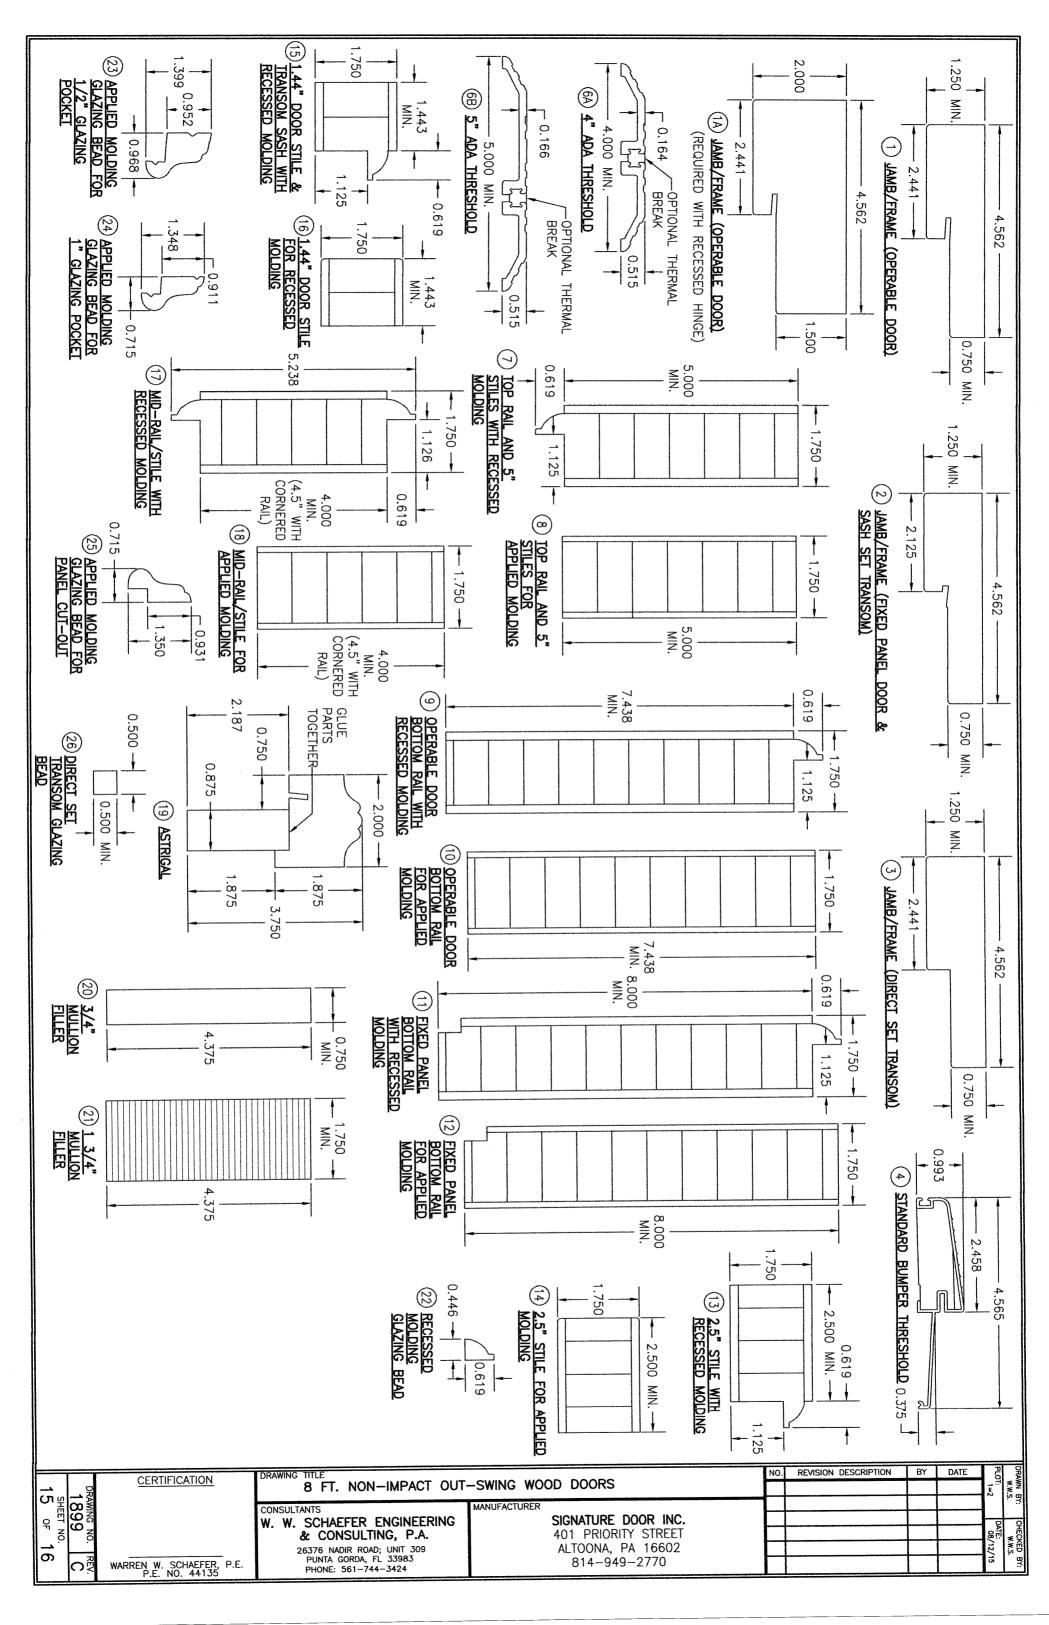

SCREW SPECIFIC GRAVITY OURS MINIMUM GRADE 2	ACTIVE PANEL LOCK SYSTEM ACTIVE PANEL LOCK SYSTEM MULTI-POINT ACTIVE PANEL LOCK SYSTEM PLUS 53-TB SURFACE BOLTS STRIP SEALS & SEALANTS STRIP 1/4" SINGLE SIDED GLAZING TAPE FASTENERS	3/4" MULLION FILLER 1 3/4" MULLION FILLER 1 3/4" MULLION FILLER RECESSED MOLDING GLAZING BEAD APPLIED MOLDING GLAZING BEAD FOR 1/2" GLAZING POCKET APPLIED MOLDING GLAZING BEAD FOR 1" GLAZING POCKET APPLIED MOLDING GLAZING BEAD FOR PANEL CUT-OUT DIRECT SET TRANSOM GLAZING BEAD ACTIVE PANEL STILE REINFORCEMENT (STAINLESS STEEL) INACTIVE PANEL STILE REINFORCEMENT HEAD & SILL STRIKE PLATE HEAD & SILL STRIKE PLATE LOCK SIDE STRIKE PLATE HOOD THRESHOLD HARDWARE 4" X 4" BUTT HINGE (STEEL, STAINLESS STEEL OR BRASS) LATCH & DEADBOLT RECESSED HINGE	ITEM # ITEM DESCRIPTION PARTS 1 JAMB/FRAME (OPERABLE DOOR) 1A JAMB/FRAME (REQUIRED WITH RECESSED HINGES) 2 JAMB/FRAME (REQUIRED WITH RECESSED HINGES) 3 JAMB/FRAME (FIXED PANEL DOOR & SASH SET TRANSOM) 4 STANDARD BUMPER THRESHOLD 6A 4" ADA THRESHOLD 6B 5" ADA THRESHOLD 7 TOP RAILS & 5" STILES WITH RECESSED MOLDING 8 TOP RAILS & 5" STILES FOR APPLIED MOLDING 10 OPERABLE DOOR BOTTOM RAIL WITH RECESSED MOLDING 11 FIXED PANEL BOTTOM RAIL FOR APPLIED MOLDING 12 FIXED PANEL BOTTOM RAIL FOR APPLIED MOLDING 13 2.5" STILE WITH RECESSED MOLDING 14 2.5" STILE WITH RECESSED MOLDING 15 1.44" STILE FOR APPLIED MOLDING 16 1.44" STILE FOR APPLIED MOLDING 17 MID-RAIL/STILE FOR APPLIED MOLDING 18 MID-RAIL/STILE WITH RECESSED MOLDING 19 ASTRIGAL
2 PER LOCK STRIKE PART NO. 29 4 PER REINFORCEMENT PLATE WITHIN 6" OF CORNERS AND 16" MAX. O.C. 2 PER JAMB SIDE LEAF; 4 PER PANEL SIDE LEAF 2 PER JAMB SIDE LEAF; 4 PER PANEL SIDE LEAF 3" FROM ENDS AND MAX. 22" O.C. (2 ROWS) WITHIN 2" OF CORNERS AND 8" MAX. O.C. WITHIN 2" OF CORNERS AND 8" MAX. O.C. WITHIN 1 1/2" OF CORNERS AND 5" MAX. O.C. WITHIN 1 1/2" OF CORNERS AND 5" MAX. O.C. WITHIN 1 1/2" OF CORNERS AND 5" MAX. O.C. TE PINE WITH A SPECIFIC GRAVITY OF G = 1. OTHER WOOD SPECIES APPLICABLE FOR USE F 0.36 AND MODULUS OF ELASTICITY OF MILLED BY SIGNATURE DOOR, INC. TO SELECT.	OPTION A: TRUTH SENTRY LEVER ACTIVATED OPTION B: HOPPE HLS9000 HANDLE OR LEVER ACTIVATED OPTION C: GU EUROPA HANDLE ACTIVATED OPTION A: TRUTH SENTRY TONGUE OPTION C: GU RHINO OPTION A: TRUTH SENTRY TONGUE OPTION B: HOPPE HLS9000 OPTION B: HOPPE HLS9000 OPTION C: GU RHINO OPTION C: GU RHINO TREQUIRED WITH SINGLE PANEL DOORS) FENSEAL DSFC-650K162-PF588 OR LAUREN DOOR SEALS PART #103257 IMPERIAL FBS30B/FBS36B PVC FOAM	PPESS ESS	MANUFACTURER/NOTES SOLID OR FINGER JOINTED WOOD (LAMINATED WITH CURVED JAMB) SOLID OR FINGER JOINTED WOOD (LAMINATED WITH CURVED JAMB) SOLID OR FINGER JOINTED WOOD (LAMINATED WITH CURVED JAMB) SOLID OR FINGER JOINTED WOOD (LAMINATED WITH CURVED JAMB) SOLID OR FINGER JOINTED WOOD (LAMINATED WITH CURVED JAMB) SOLID OR FINGER JOINTED WOOD (LAMINATED WITH CURVED JAMB) SOLID OR FINGER JOINTED WOOD (LAMINATED WITH CURVED JAMB) SOLID OR FINGER JOINTED WOOD (LAMINATED WITH CURVED JAMB) ALUMINUM ALUMINUM ALUMINUM LVL OR LAMINATED RED OAK CORE (PINE VENEER)
30) HEAD & SILL STRIKE THICKNESS = 1/8" USED WITH 2-POINT ONLY INACT 0.893 1.564 0.893 1.564 33) OPTIONAL WOOD THRESHOLD	NESS = 1 ACTIVE PANS SIDE $\phi 1/4$ " (TYP.)	0.375 3.500 4.187 2.430 2.8) INACTIVE PANEL STILE REINFORCEMENT THICKNESS = 1/8" SILL SCREWS TO SUBSTRATE SHALL BE PLACED IN THE DARKENED HOLES SHOWN!! 0.625 0.37	1.250 — 2.437 — 3.375 — 2.437 — 2.437 — 11.000 — 11.000 — 0.656 — 0.65
L STRIKE PLATE 1/8" ONLY INACTIVE PANEL LOCK SYSTEMS CERTIFICATION	& 2-P0 & 2-P0 1.125	RIOR SIDE (T	NO. REVISION DESCRIPTION BY DATE TO THE TOTAL