

MIAMI-DADE COUNTY PRODUCT CONTROL SECTION

11805 SW 26 Street, Room 208 Miami, Florida 33175-2474 T (786) 315-2590 F (786) 315-2599 www.miamidade.gov/economy

DEPARTMENT OF REGULATORY AND ECONOMIC RESOURCES (RER) BOARD AND CODE ADMINISTRATION DIVISION

NOTICE OF ACCEPTANCE (NOA)

Stanley Access Technologies, LLC 65 Scott Swamp Road Farmington, CT 06032

Scope:

This NOA is being issued under the applicable rules and regulations governing the use of construction materials. The documentation submitted has been reviewed and accepted by Miami-Dade County RER -Product Control Section to be used in Miami Dade County and other areas where allowed by the Authority Having Jurisdiction (AHJ).

This NOA shall not be valid after the expiration date stated below. The Miami-Dade County Product Control Section (In Miami Dade County) and/or the AHJ (in areas other than Miami Dade County) reserve the right to have this product or material tested for quality assurance purposes. If this product or material fails to perform in the accepted manner, the manufacturer will incur the expense of such testing and the AHJ may immediately revoke, modify, or suspend the use of such product or material within their jurisdiction. RER reserves the right to revoke this acceptance, if it is determined by Miami-Dade County Product Control Section that this product or material fails to meet the requirements of the applicable building code.

This product is approved as described herein and has been designed to comply with the Florida Building Code, including the High Velocity Hurricane Zone.

DESCRIPTION: Series "Dura Storm" Aluminum Automatic Sliding Glass Door: O-Sx-Sx-O, Sx-O w/wo Transom, So-Sx-Sx-So and Sx-So w/wo Transom & Breakout –NI

APPROVAL DOCUMENT: Drawing No. **20-33204** (former **14-1854**), titled "Dura-Storm 2000/3000 Auto SGD Bi-Parting/Single Slide-NI", sheets 1 through 19 of 19, prepared by Engineering Express, dated 07/01/12 and last revised on 11/24/2020, signed and sealed by Frank L. Bennardo, P.E., bearing the Miami-Dade County Product Control Revision stamp with the Notice of Acceptance number and expiration date by the Miami-Dade County Product Control Section.

MISSILE IMPACT RATING: None. Approved Hurricane Protection devices are required per FBC, as applicable.

- 1. See elevation for anchors requirements in sheets 1,2 & 3 and Header clusters details in sheet 7 and Threshold clusters in sheet 12. The 1/4" Power Tapper anchors at head/Jamb & Sill to be in min 3 Ksi concrete. See sheets 4,5 & 6 for concealed 3-point locking (active panel) & 2-point (in-active). Also see applicable 2-point G-86 CVR panic devices (active/inactive panels) for series 3000 in sheets 5 & 6 to be used w/ Horizontal muntin bars (detail V, sheet 15) and DLO height not to exceed 36-3/4" max.
- 2. See details 1A/8, 3A/9 & 5A/10 for Transom nested reinforcements item #101 for Bi-Parting series 2000 (O-Sx-Sx-O) and series 3000 (So-Sx-Sx-So). The Single Slide O-Sx and So-Sx require light reinforcement item #73.
- 3. Electrical devices, functions and installation is not part of this approval and to be reviewed and approved by Authority Having Jurisdiction (AHJ)
- 4. See Door panel and Transom glazing details in sheets 16 & 18. Fixed glass more than 36" wide must be supported with approved setting blocks per FBC requirements.
- 5. Not approved where water infiltration is required.

LABELING: Each unit shall bear a permanent label with the manufacturer's name or logo, city, state and series and following statement: "Miami-Dade County Product Control Approved", unless otherwise noted herein.

RENEWAL of this NOA shall be considered after a renewal application has been filed and there has been no change in the applicable building code negatively affecting the performance of this product.

TERMINATION of this NOA will occur after the expiration date or if there has been a revision or change in the materials, use, and/or manufacture of the product or process. Misuse of this NOA as an endorsement of any product, for sales, advertising or any other purposes shall automatically terminate this NOA. Failure to comply with any section of this NOA shall be cause for termination and removal of NOA.

MIAMI-DADE COUNTY
APPROVED

Ishaq I. Chands

NOA No. 20-1216.25 Expiration Date: April 11, 2023 Approval Date: February 04, 2021 Page 1 of 2

Stanley Access Technologies, LLC

ADVERTISEMENT: The NOA number preceded by the words Miami-Dade County, Florida, and followed by the expiration date may be displayed in advertising literature. If any portion of the NOA is displayed, then it shall be done in its entirety.

INSPECTION: A copy of this entire NOA shall be provided to the user by the manufacturer or its distributors and shall be available for inspection at the job site at the request of the Building Official.

This NOA revises NOA # 18-0221.09 and consists of page 1, this page 2 and evidence pages E-1, E-2 and E-3, as well as approval document mentioned above.

The submitted documentation was reviewed by Ishaq I. Chanda, P.E.

Ishaq I. Chands



NOA No. 20-1216.25 Expiration Date: April 11, 2023 Approval Date: February 04, 2021

Page 2 of 2

NOTICE OF ACCEPTANCE: EVIDENCE SUBMITTED

1. EVIDENCE SUBMITTED UNDER PREVIOUS NOA'S

A. DRAWINGS

- 1. Manufacturer's die drawings and sections (submitted under files below)
- 2. Drawing No. **14-1854** (former **12-SAT-15**), titled "Dura-Storm 2000/3000 Bi-Parting /Single slide-NI", sheets 1 through 19 of 19, prepared by Engineering Express, dated 07-01-12 and last revised on 10/14/2014, signed and sealed by Frank L. Bennardo, P.E.
- **B.** TESTS (submitted under files # 13-0529.21/#12-0807.05)
 - 1. Test reports on: 1) Air Infiltration Test, per FBC, TAS 202-94
 - 2) Uniform Static Air Pressure Test, Loading per FBC TAS 202-94
 - 3) Water Resistance Test, per FBC, TAS 202-94 (Not conducted)
 - 4) Forced Entry Test, per FBC 2411 3.2.1, TAS 202-94

Along with installation diagram of aluminum automatic entrance doors Sx-So w/ G-86 CVR Panic and So-Sx-Sx-So w/ Transom & G-86 CVR Panic, prepared by Fenestration Testing Laboratory, Inc. Test Report No. FTL-7247, dated 03/08/13, signed and sealed by Marlin D. Brinson, P. E.

- 2. Test reports on: 1) Air Infiltration Test, per FBC, TAS 202-94
 - 2) Uniform Static Air Pressure Test, Loading per FBC TAS 202-94
 - 3) Water Resistance Test, per FBC, TAS 202-94 (Not conducted)
 - 4) Forced Entry Test, per FBC 2411 3.2.1, TAS 202-94

Along with installation diagram of aluminum automatic entrance doors, prepared by Fenestration Testing Laboratory, Inc. Test Report No. **FTL-6803**, dated 05/11/12 and last revised on 03/21/13, signed and sealed by Marlin D. Brinson, P. E.

Note: This test report has been revised by an addendum letters dated Nov 21, 2012 and April 03, 2013, issued by Fenestration Testing Lab, signed and sealed by Marlin D. Brinson, P. E. (submitted under file # 12-0807.05)

C. CALCULATIONS

- 1. Anchor verification calculations and structural analysis, complying with FBC-2014 (5th Edition), prepared by Engineering Express, dated 05-13-15, signed and sealed by Frank L. Bennardo, P.E.
- 2. Glazing complies w/ ASTME-1300-02, -04 & -09.

D. QUALITY ASSURANCE

1. Miami Dade Department of Regulatory and Economic Resources (RER).

E. MATERIAL CERTIFICATIONS (submitted under file # 12-0807.05)

1. Technical strength data of Trelleborg EPDM per ASTM C864.

F. STATEMENTS

- 1. Statement letter of conformance to FBC 2014(5th Edition), prepared by Engineering Express, dated May 13, 2015, signed and sealed by Frank L. Bennardo, P.E.
- 2. Statement letter of no financial interest, prepared by Engineering Express, dated 08-02-12, signed and sealed by Frank L. Bennardo, P.E. (submitted under file # 12-0807.05)
- 3. Lab compliance as part of the above referenced test report.

Ishaq I. Chands

Ishaq I. Chanda, P.E.
Product Control Unit Supervisor
NOA No. 20-1216.25
Expiration Date: April 11, 2023
Approval Date: February 04, 2021

NOTICE OF ACCEPTANCE: EVIDENCE SUBMITTED

G. OTHER

- 1. This NOA revises NOA #13-0529.21, expiring 04/18/18.
- 2. Test proposals # 13-0006 dated 01/14/13 approved by RER and # 11-1016, dated NOV 11, 2011 approved by PERA.
- 3. Manufacture supplied Adam Rites deadbolt/hook & bolts mechanism & G-86 panic brochures.

2. EVIDENCE SUBMITTED UNDER PREVIOUS APPROVAL #17-0828.09

A. DRAWINGS

1. Drawing No. **14-1854**, titled "Dura-Storm 2000/3000 Auto SGD Bi-Parting /Single Slide-NI", sheets 1 through 19 of 19, prepared by Engineering Express, dated 07/01/12 and last revised on 08/23/17, signed and sealed by Frank L. Bennardo, P.E.

B. TESTS

1. None.

C. CALCULATIONS

1. Anchor verification calculations and structural analysis, complying with **FBC** 6th **Edition** (2017), prepared by manufacturer, dated 08/01/17, signed and sealed by Frank L. Bennardo, P.E.

D. QUALITY ASSURANCE

1. Miami Dade Department of Regulatory and Economic Resources (RER).

E. MATERIAL CERTIFICATIONS

1. None.

F. STATEMENTS

- 1. Statement letter of conformance to **FBC** 6th **Edition (2017)**, dated 07/31/17, prepared by Engineering Express, signed and sealed by Frank L. Bennardo, P.E.
- 2. Statement letter of no financial interest, prepared by Engineering Express, dated 07/28/17, signed and sealed by Frank L. Bennardo, P.E.

G. OTHER

1. This NOA revises NOA #15-0127.05, expiring on 04/11/2018.

3. EVIDENCE SUBMITTED submitted under previous NOA

A. DRAWINGS

1. None.

B. TESTS

1. None.


Ishaq I. Chanda


Ishaq I. Chanda, P.E.
Product Control Unit Supervisor
NOA No. 20-1216.25
Expiration Date: April 11, 2023
Approval Date: February 04, 2021

NOTICE OF ACCEPTANCE: EVIDENCE SUBMITTED

- 3. EVIDENCE SUBMITTED (continue)
- C. CALCULATIONS
 - 1. None.
- D. QUALITY ASSURANCE
 - 1. Miami Dade Department of Regulatory and Economic Resources (RER).
- E. MATERIAL CERTIFICATIONS
 - 1. None.
- F. STATEMENTS
 - 1. None.
- G. OTHER
 - 1. This NOA renews NOA #17-0828.09, expiring on 04/11/2018.
- 4. New EVIDENCE SUBMITTED
- A. DRAWINGS
 - 1. Drawing No. **20-33204** (former **14-1854**), titled "Dura-Storm 2000/3000 Auto SGD Bi-Parting /Single Slide-NI", sheets 1 through 19 of 19, prepared by Engineering Express, dated 07/01/12 and last revised on 11/24/2020, prepared by Engineering Express, signed and sealed by Frank L. Bennardo, P.E.
- B. TESTS
 - 1. None.
- C. CALCULATIONS
 - 1. None.
- D. QUALITY ASSURANCE
 - 1. Miami Dade Department of Regulatory and Economic Resources (RER).
- E. MATERIAL CERTIFICATIONS
 - 1. Technical strength data of Trelleborg EPDM per ASTM C864.
- F. STATEMENTS
 - 1. Statement letter of conformance to FBC 2020 (7th Edition), prepared by Engineering Express, dated 11/25/20, signed and sealed by Frank L. Bennardo, P.E.
 - 2. Statement letter dated 11/25/20 referenced to general updated code note change only, prepared by Engineering Express, dated 11/25/20, signed and sealed by Frank L. Bennardo, P.E.
- G. OTHER
 - 1. This NOA revises NOA #18-0221.09, expiring 04/11/23.

Ishaq I. Chands

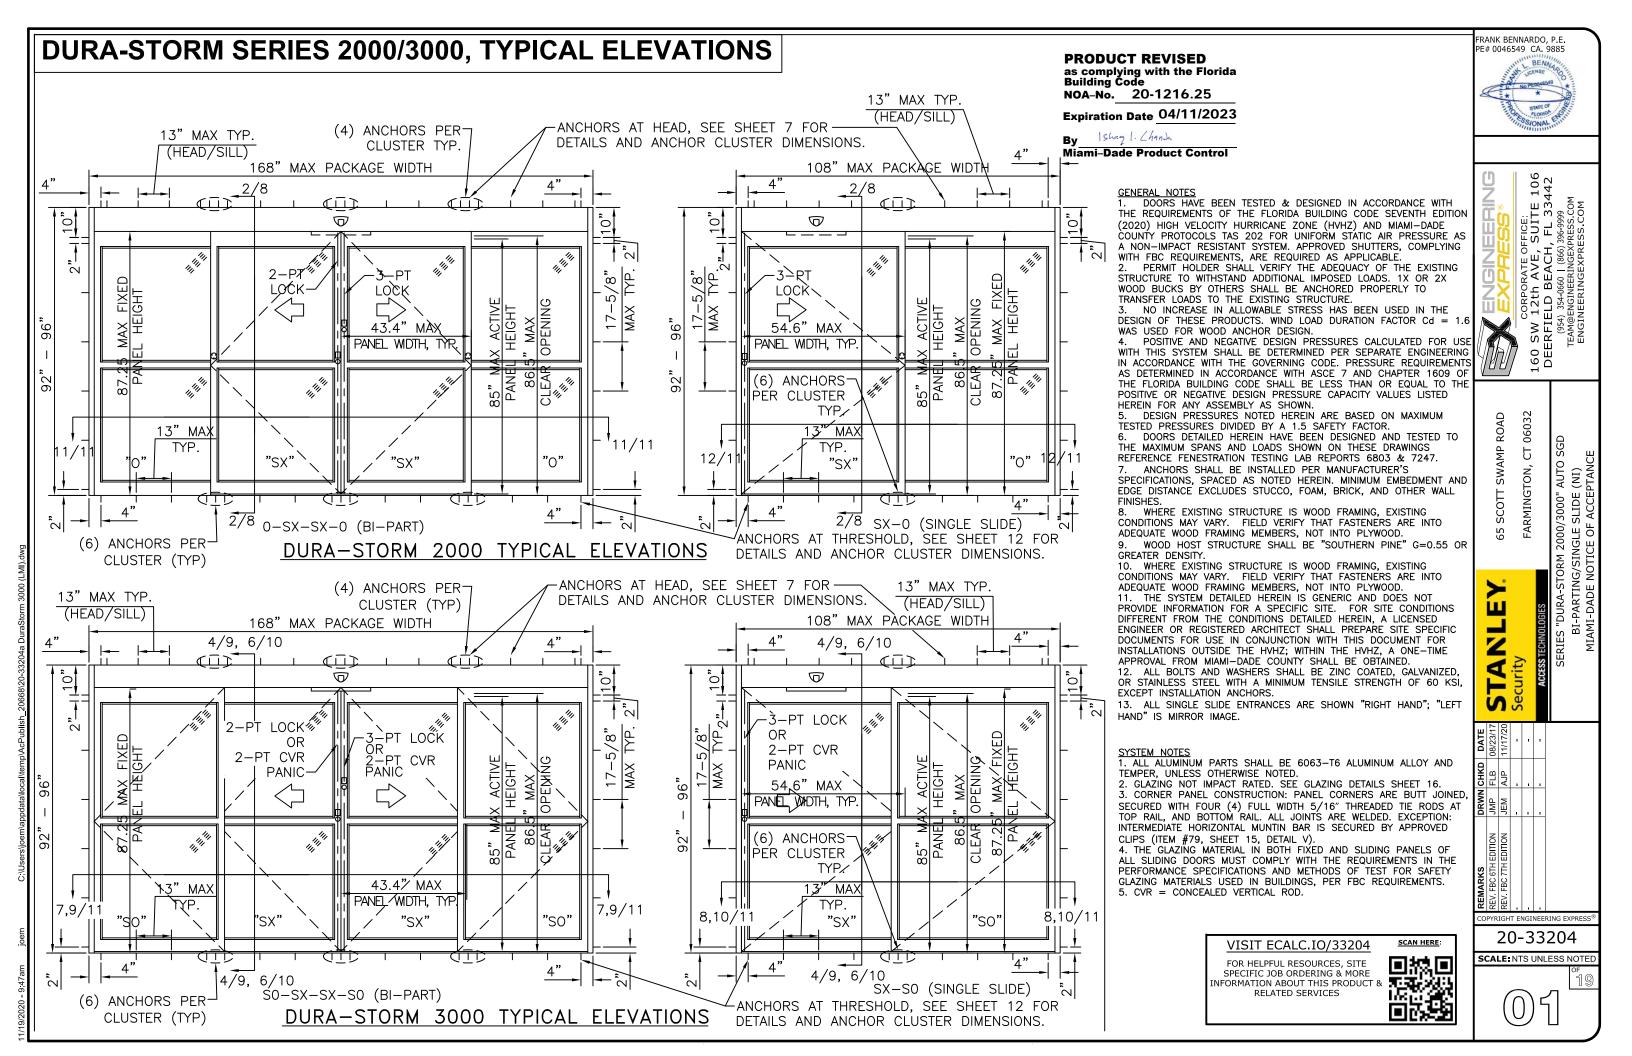

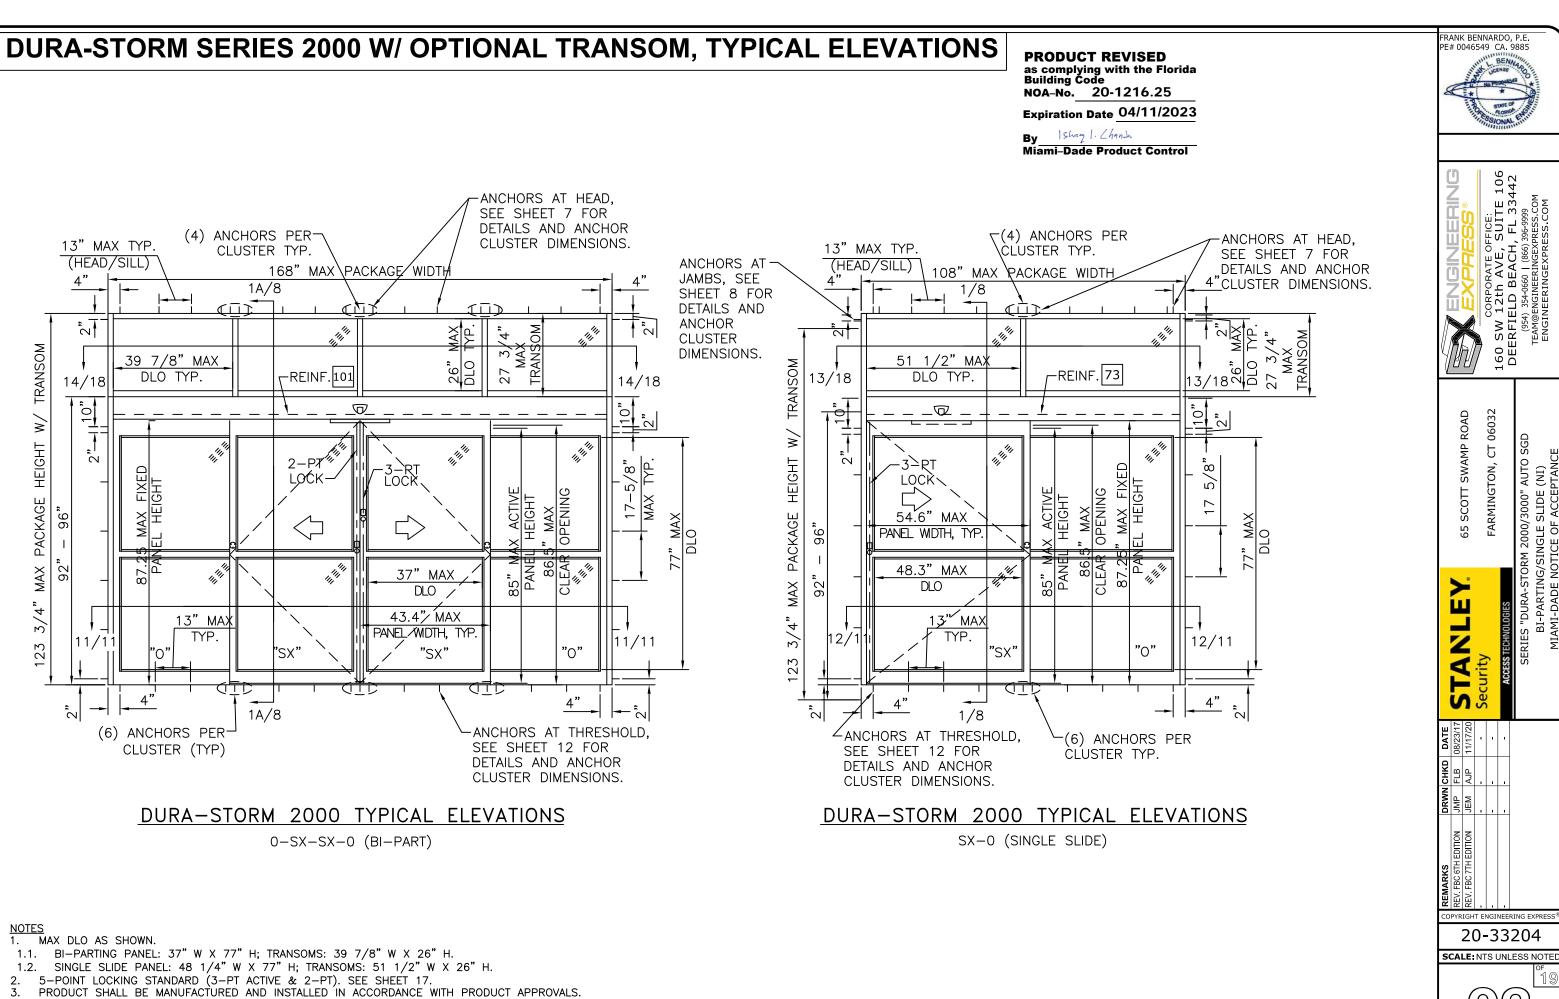

SEE SHEETS 7, 8, 11 AND 12 FOR REQUIRED ANCHORAGE.

SEE SHEET 16 FOR GLAZING DETAILS.


DURA-STORM SERIES 3000 W/ OPTIONAL TRANSOM, TYPICAL ELEVATIONS

PRODUCT REVISED as complying with the Florida Building Code NOA-No. 20-1216.25

Expiration Date 04/11/2023

Ishaq I. Chank

Miami-Dade Product Control

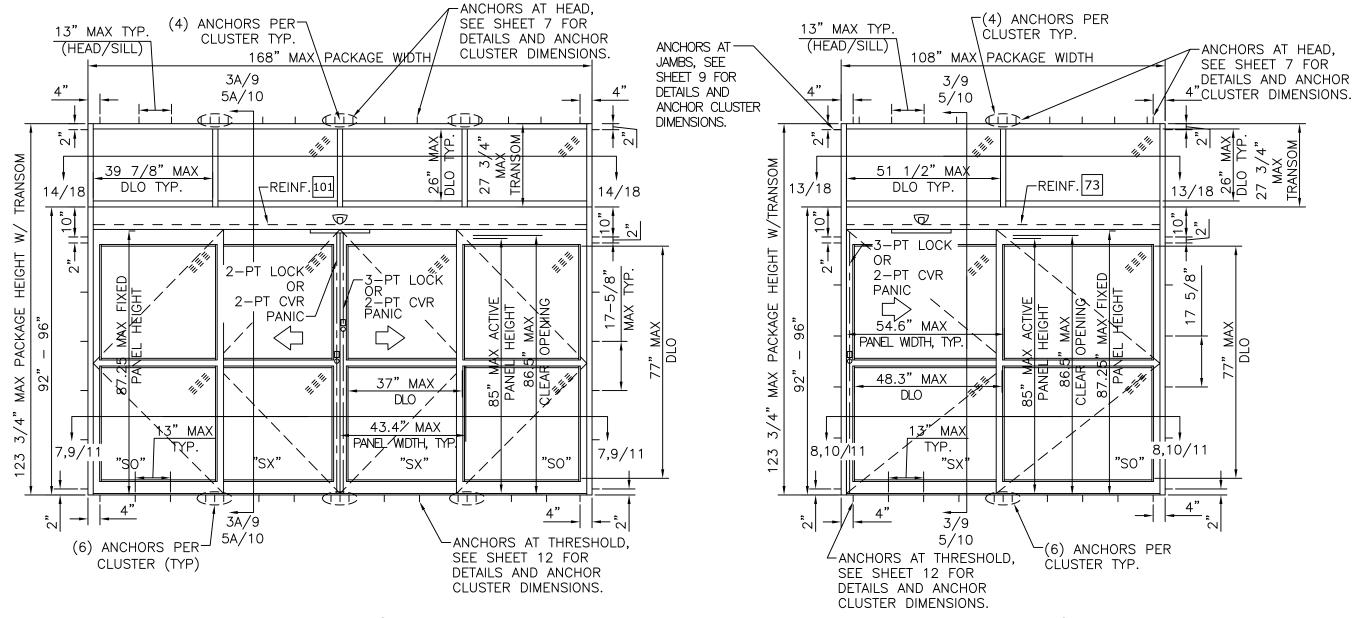

DURA-STORM 3000 TYPICAL ELEVATIONS

S0-SX-SX-S0 (BI-PART)

DURA-STORM 3000 TYPICAL ELEVATIONS

SX-SO (SINGLE SLIDE)

MAX DLO AS SHOWN.

- BI-PARTING PANEL: 37" W X 77" H, 36 3/4" H WITH PANIC MUNTIN; TRANSOMS: 39 7/8" W X 26" H.
- SINGLE SLIDE PANEL: 48 1/4" W X 77" H, 36 3/4" H WITH PANIC MUNTIN; TRANSOMS: 51 1/2" W X 26" H.
- 4-POINT CVR LOCKING WITH G86 PANIC RELEASE (2-PT CVR ACTIVE & 2-PT CVR) AND 5-POINT LOCKING (3-PT ACTIVE & 2-PT) AVAILABLE. SEE SHEET 17. PRODUCT SHALL BE MANUFACTURED AND INSTALLED IN ACCORDANCE WITH PRODUCT APPROVALS.

 SEE SHEETS 7, 9, 10, 11 AND 12 FOR REQUIRED ANCHORAGE.

 SEE SHEET 16 FOR GLAZING DETAILS.



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TEAM@ENGINEERINGEXPRESS.COM
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06032 \Box FARMINGTON,

ZAZ S

20-33204

SCALE: NTS UNLESS NOTED




DURA-STORM SERIES 2000 ELEVATION AND PLAN

PRODUCT REVISED as complying with the Florida Building Code NOA-No. 20-1216.25

Expiration Date 04/11/2023

Ishaq I. Chank

-(22)-(17)(22)-(22)(22)-(24)-(25)

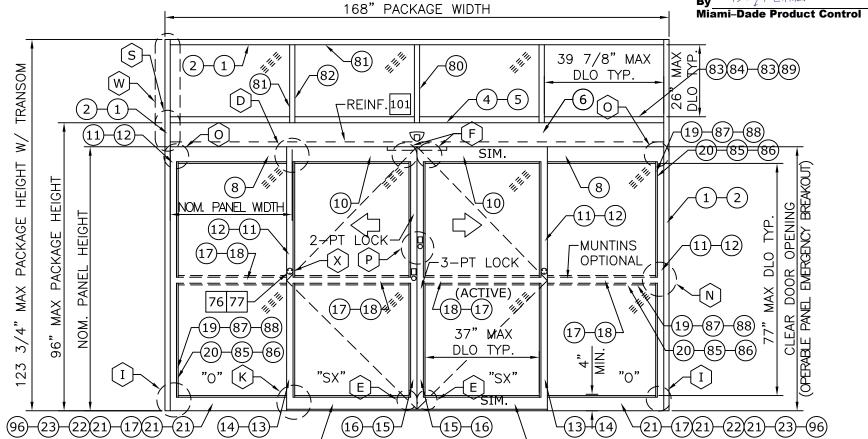

(0-SX-SX-0)

EXTERIOR ELEVATION

168"

PACKAGE WIDTH

(XX): EXTRUSION


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(XX)—(XX): EXTRUSION, OPTION XX : PART

|XX|XX|: PART, MULTI-PIECE XX XX : PART, OPTION

(XX): DETAIL

[XX]—[XX]: DETAIL, OPTION

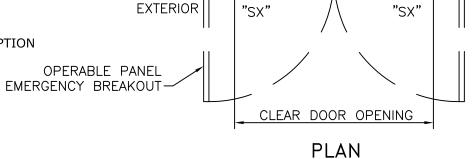



- HORIZONTAL MUNTIN BAR NOT REQUIRED AS INDICATED BY DASHED LINES. MAX DLO: 37" W X 77" H AS SHOWN
- 5-POINT LOCKING STANDARD (3-PT ACTIVE & 2-PT). SEE SHEET 17. PRODUCT SHALL BE MANUFACTURED AND INSTALLED IN ACCORDANCE WITH PRODUCT APPROVALS.
- SEE SHEETS 7, 8, 11, AND 12 FOR REQUIRED ANCHORAGE. SEE SHEET 16 FOR GLAZING DETAILS.

| DESIGN RATING | <u>SS</u> |
|---|--|
| CT RATING | |
| NON-IMPACT RESISTANT | |
| | |
| SSURE RATING (PSF[Pa]) | |
| WHERE WATER INFILTRATION RATING IS REQUIRED | WHERE WATER INFILTRATION RATING IS NOT REQUIRED |
| NOT APPROVED | 55 PSF |
| NOT APPROVED | 55 PSF |
| | CT RATING NON-IMPACT RESISTANT SSURE RATING (PSF[Pa]) WHERE WATER INFILTRATION RATING IS REQUIRED NOT APPROVED |

| | SERIES 2 | 2000 AVAIL | ABLE PACK | AGE WIDTH | INFORMATION | * |
|------------------|------------------|---------------|-------------------------------------|--------------------------------|-------------------------------|-----------------------|
| PACKAGE WIDTH | ROUGH OPENING | STILE TYPE | NOMINAL CLEAR DOOR OPENING | NOMINAL PANEL WIDTH (SX) | NOMINAL PANEL WIDTH (O) | CAULKING ALLOWANCE |
| 168.0" | 168.5" | NARROW | 70.6" | 42.7" | 42.7" | 1/4" / SIDE |
| 168.0" | 168.5" | MEDIUM | 66.3" | 43.4" | 43.4" | 1/4" / SIDE |

| SERIE | | 'AILABLE PACKAGE FORMATION* | HEIGHT |
|-------------------|------------------|--------------------------------|-----------------------|
| PACKAGE HEIGHT | ROUGH OPENING | NOMINAL CLEAR DOOR OPENING | CAULKING ALLOWANCE |
| 92.0" | 92.3" | 82.5" | 1/4" TOP |
| 96.0" | 96.3" | 86.5" | 1/4" TOP |

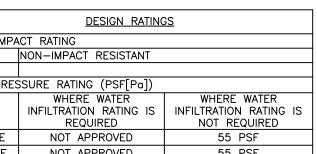

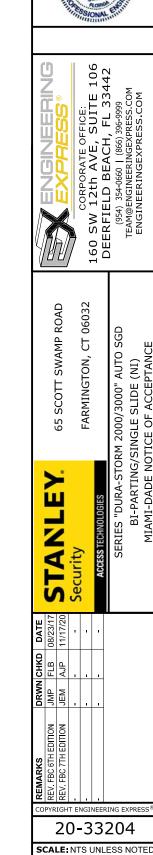


FRANK BENNARDO, P.E.

PE# 0046549 CA. 9885

TYPICAL DOOR SHOWN. STILE, RAIL AND MUNTIN OPTIONS AVAILABLE AS INDICATED.

(25)-(24)-(22)(22)-(17)(22)-(22)

INTERIOR

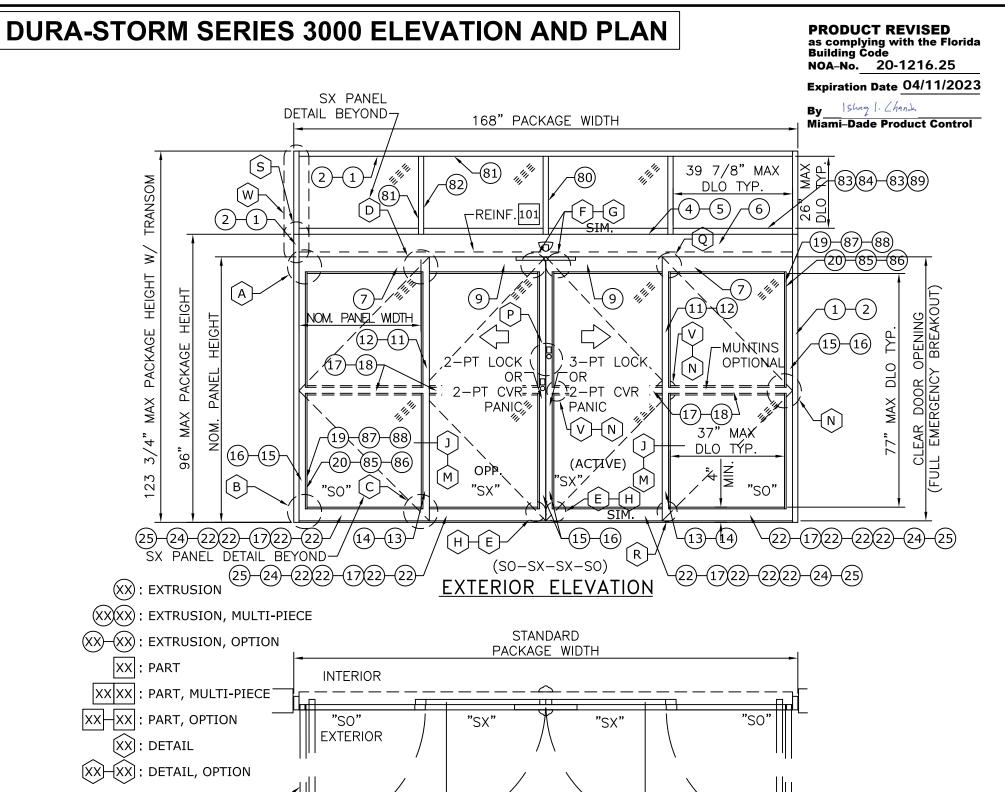

| | DESIGN RATING | <u>SS</u> |
|--------------|---|---|
| MISSILE IMPA | CT RATING | |
| | NON-IMPACT RESISTANT | |
| | | |
| DESIGN PRES | SSURE RATING (PSF[Pa]) | |
| | WHERE WATER INFILTRATION RATING IS REQUIRED | WHERE WATER INFILTRATION RATING IS NOT REQUIRED |
| POSITIVE | NOT APPROVED | 55 PSF |
| NEGATIVE | NOT APPROVED | 55 PSF |

| | SERIES | 3000 AVAIL | ABLE PACK | AGE WIDTH | INFORMATION | * |
|------------------|------------------|---------------|-------------------------------------|--------------------------------|-------------------------------|-----------------------|
| PACKAGE WIDTH | ROUGH OPENING | STILE TYPE | NOMINAL CLEAR DOOR OPENING | NOMINAL PANEL WIDTH (SX) | NOMINAL PANEL WIDTH (O) | CAULKING ALLOWANCE |
| 168.0" | 168.5" | NARROW | 70.6" | 42.7" | 42.7" | 1/4" / SIDE |
| 168.0" | 168.5" | MEDIUM | 66.3" | 43.4" | 43.4" | 1/4" / SIDE |

| SERIES 3000 AVAILABLE PACKAGE HEIGHT INFORMATION* | | | |
|---|------------------|-------------------------------|-----------------------|
| PACKAGE HEIGHT | ROUGH OPENING | NOMINAL CLEAR DOOR OPENING | CAULKING ALLOWANCE |
| 92.0" | 92.3" | 82.5" | 1/4" TOP |
| 96.0" | 96.3" | 86.5" | 1/4" TOP |



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06032 FARMINGTON,

4

20-33204

SCALE: NTS UNLESS NOTED

1. TYPICAL DOOR SHOWN. STILE, RAIL AND MUNTIN OPTIONS AVAILABLE AS INDICATED.

EMERGENCY

BREAK OUT

2. HORIZONTAL MUNTIN BAR NOT REQUIRED EXCEPT AT PANIC DEVICE, AS INDICATED BY DASHED LINES. MAX PANEL DLO: 37" W X 77 3/8" H, 36 3/4" H WITH PANIC MUNTIN AS SHOWN.


CLEAR

DOOR OPENING **PLAN**

4-POINT CVR LOCKING WITH G86 PANIC RELEASE (2-PT CVR ACTIVE & 2-PT CVR) AND 5-POINT LOCKING (3-PT ACTIVE & 2-PT) AVAILABLE. SEE SHEET 17.

PRODUCT SHALL BE MANUFACTURED AND INSTALLED IN ACCORDANCE WITH PRODUCT APPROVALS.


SEE SHEETS 7, 9, 10, 11, AND 12 FOR REQUIRED ANCHORAGE. 6. SEE SHEET 16 FOR GLAZING DETAILS.

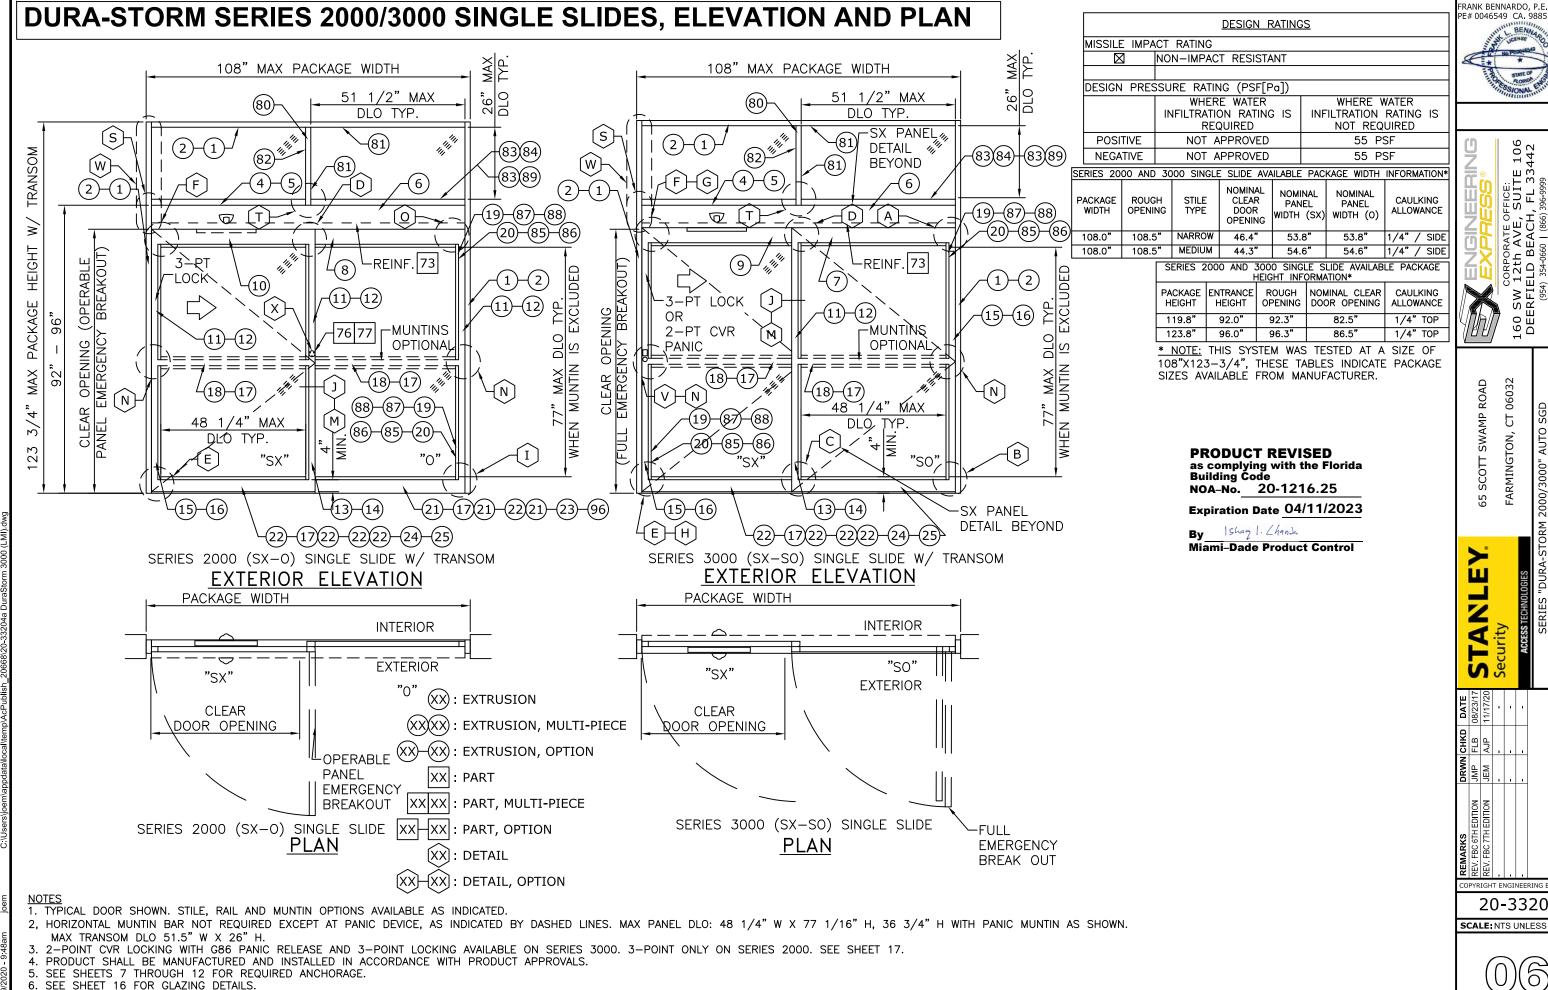



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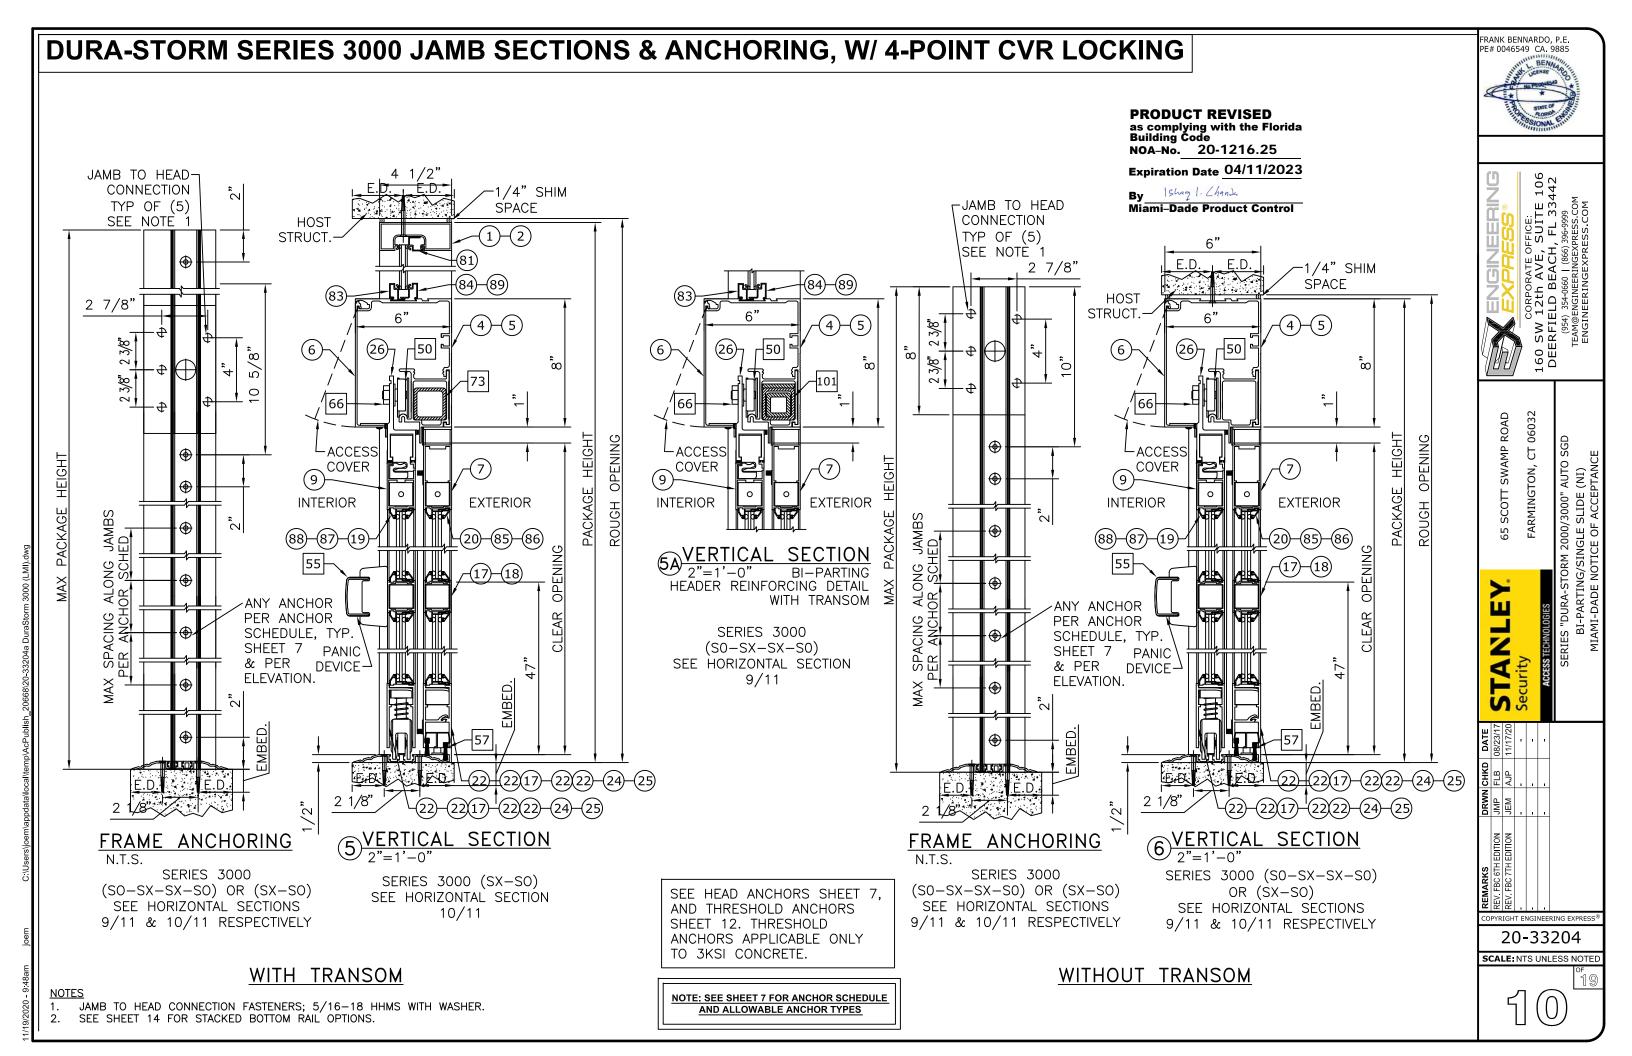
20-33204


SCALE: NTS UNLESS NOTED




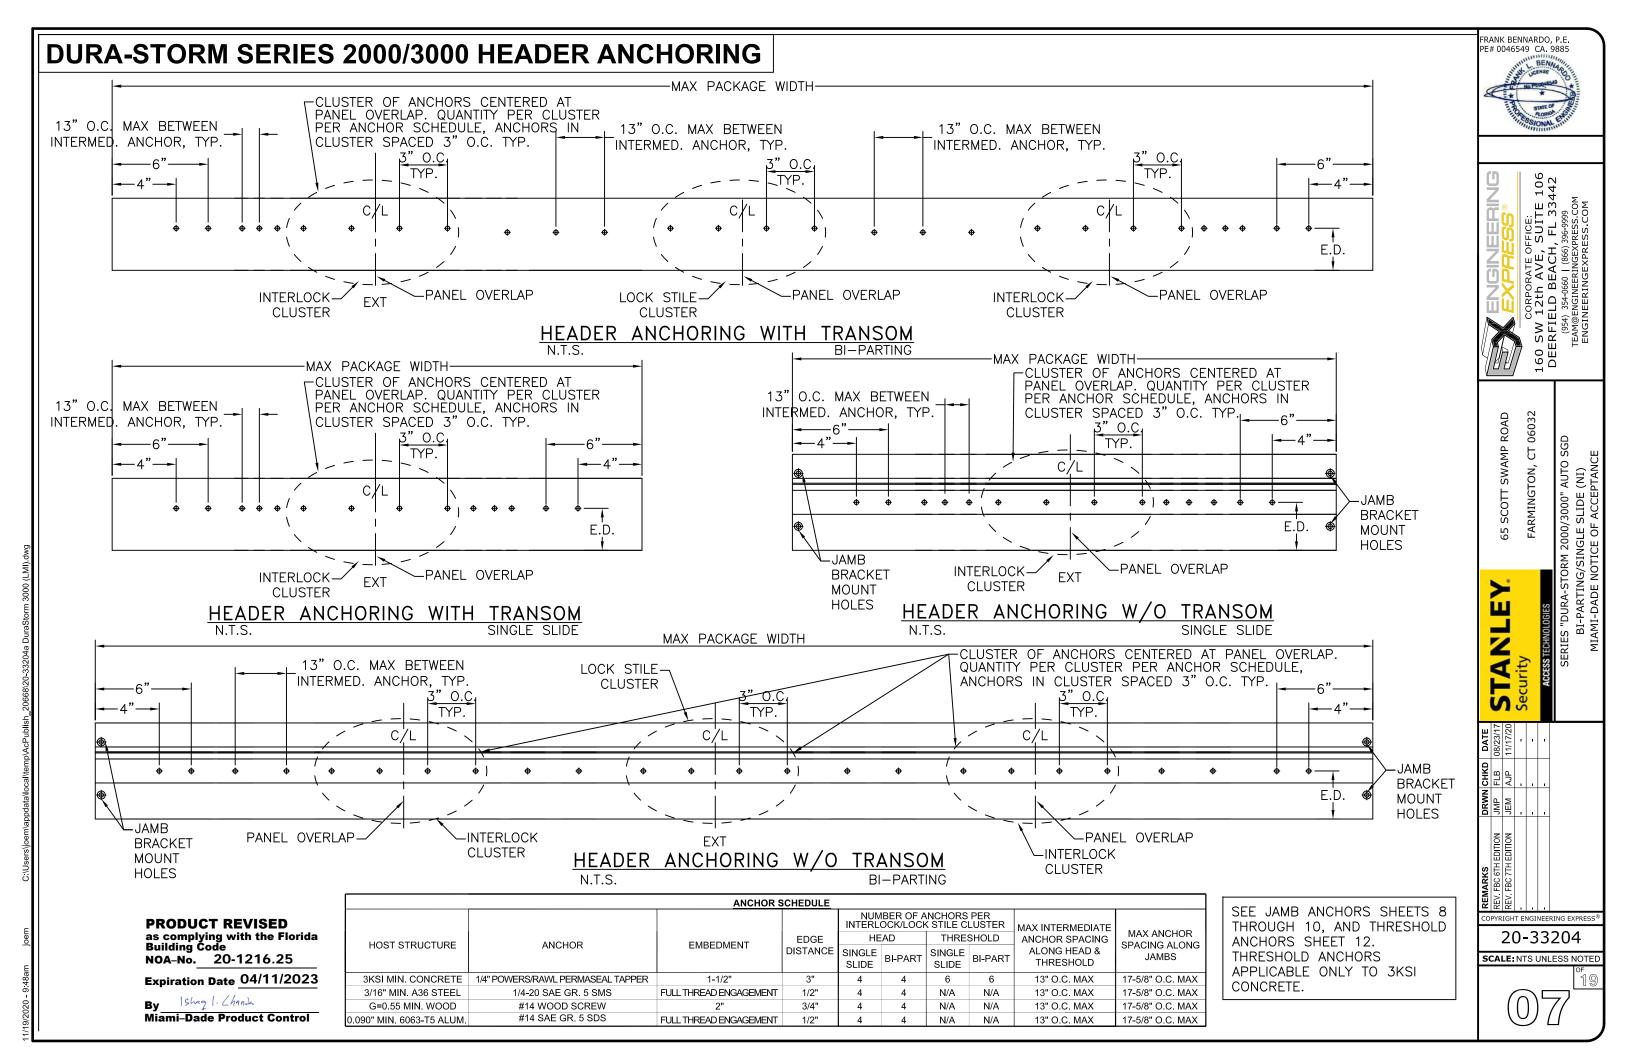


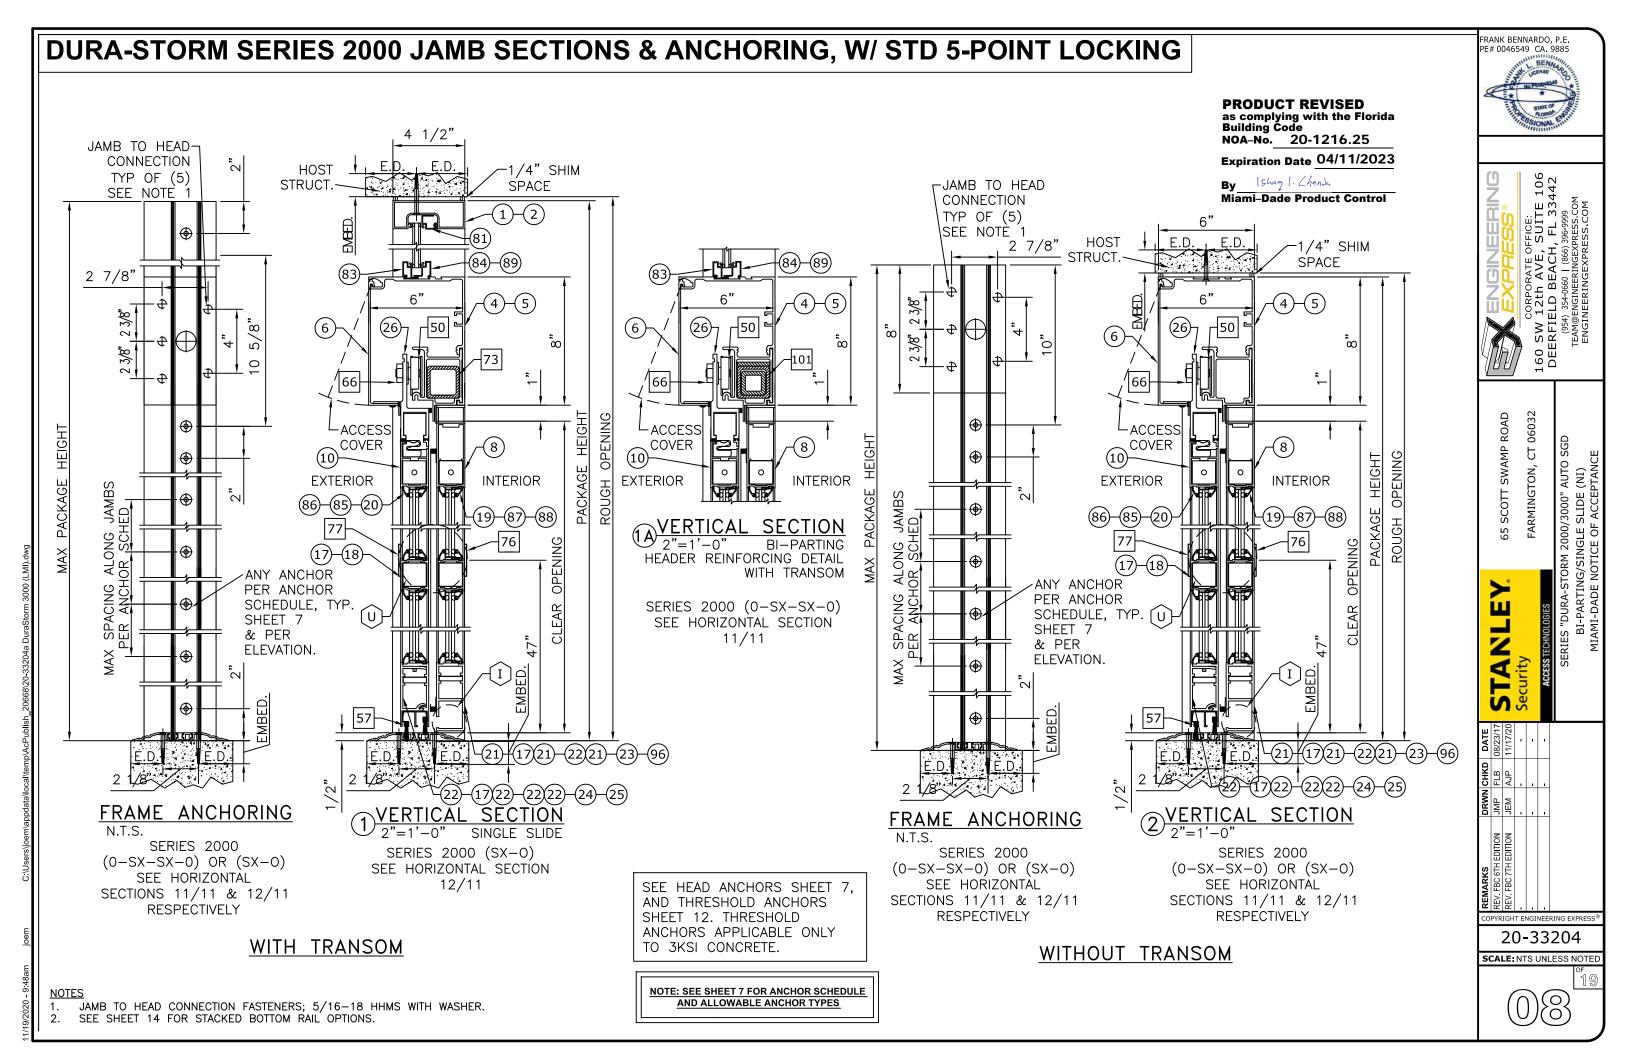


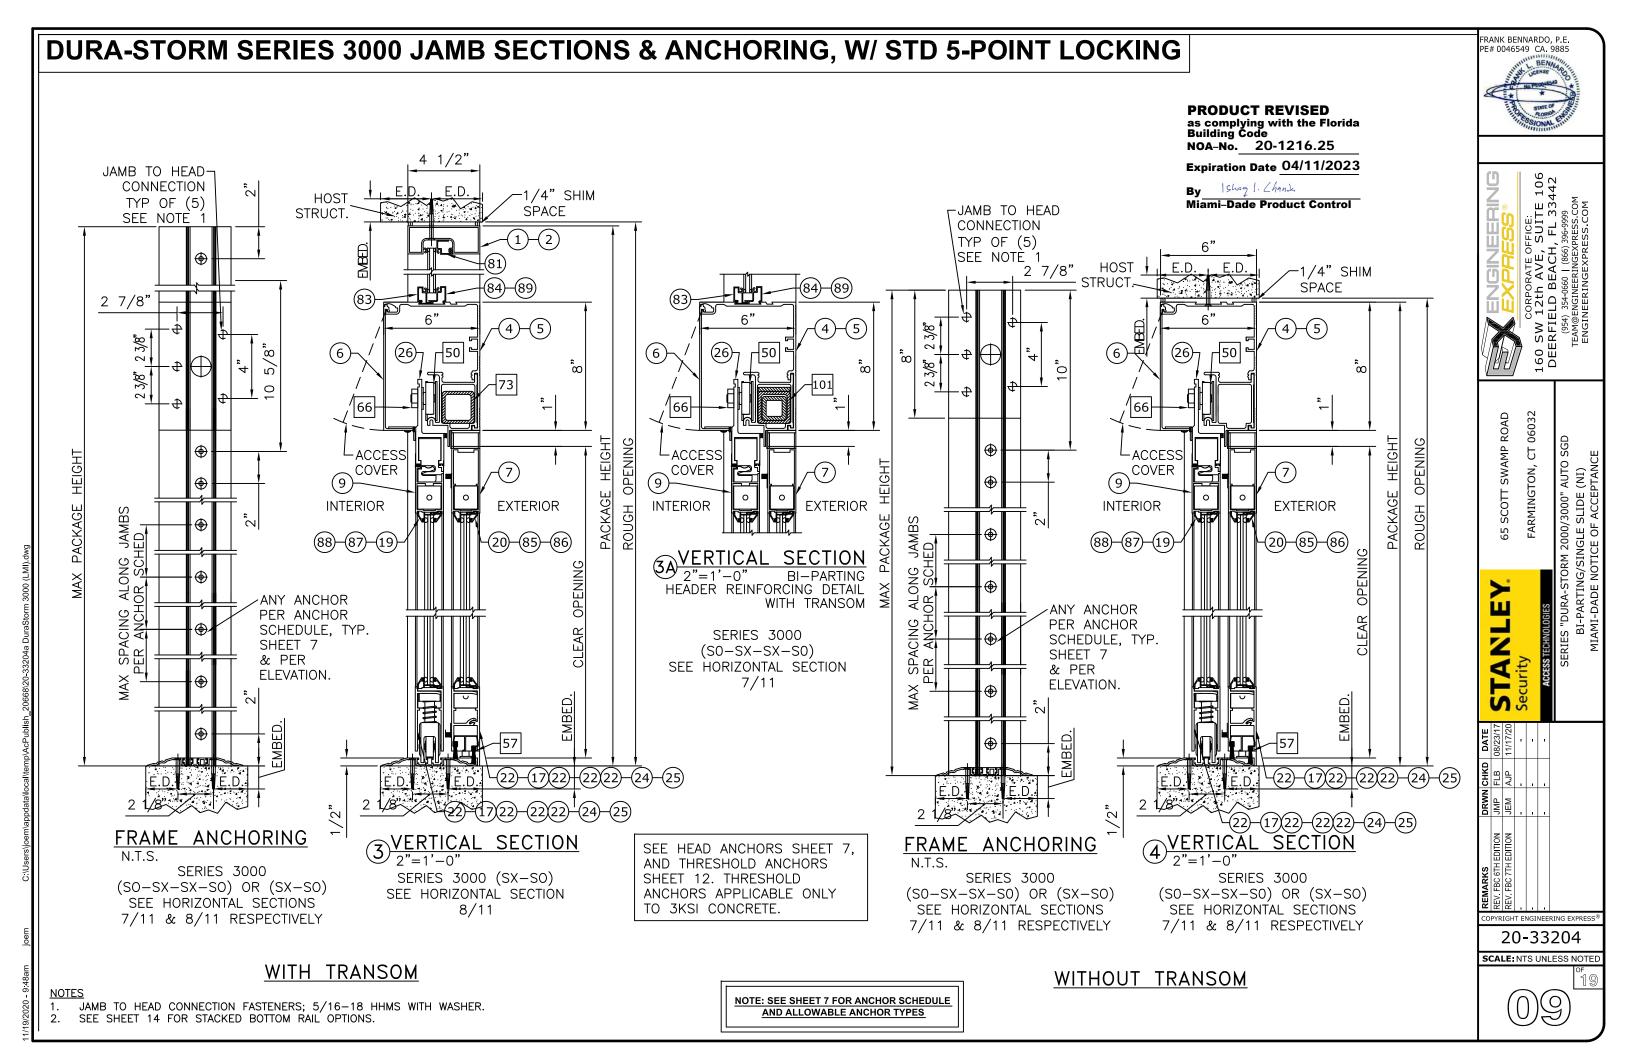

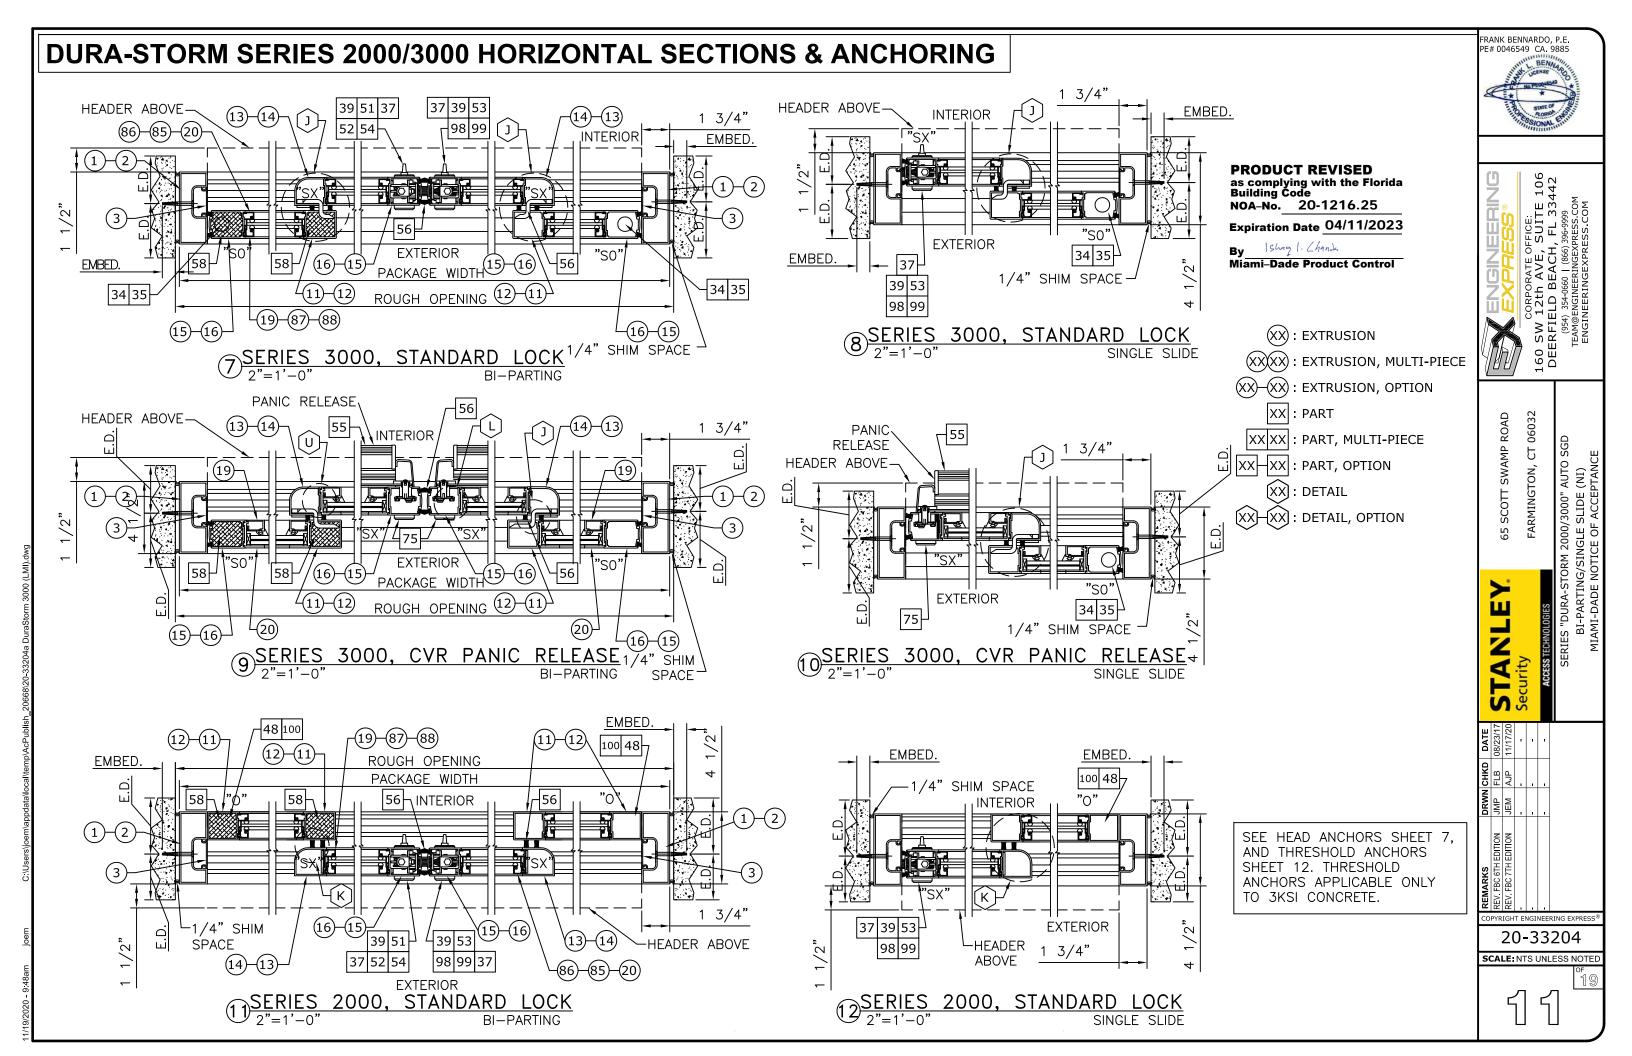

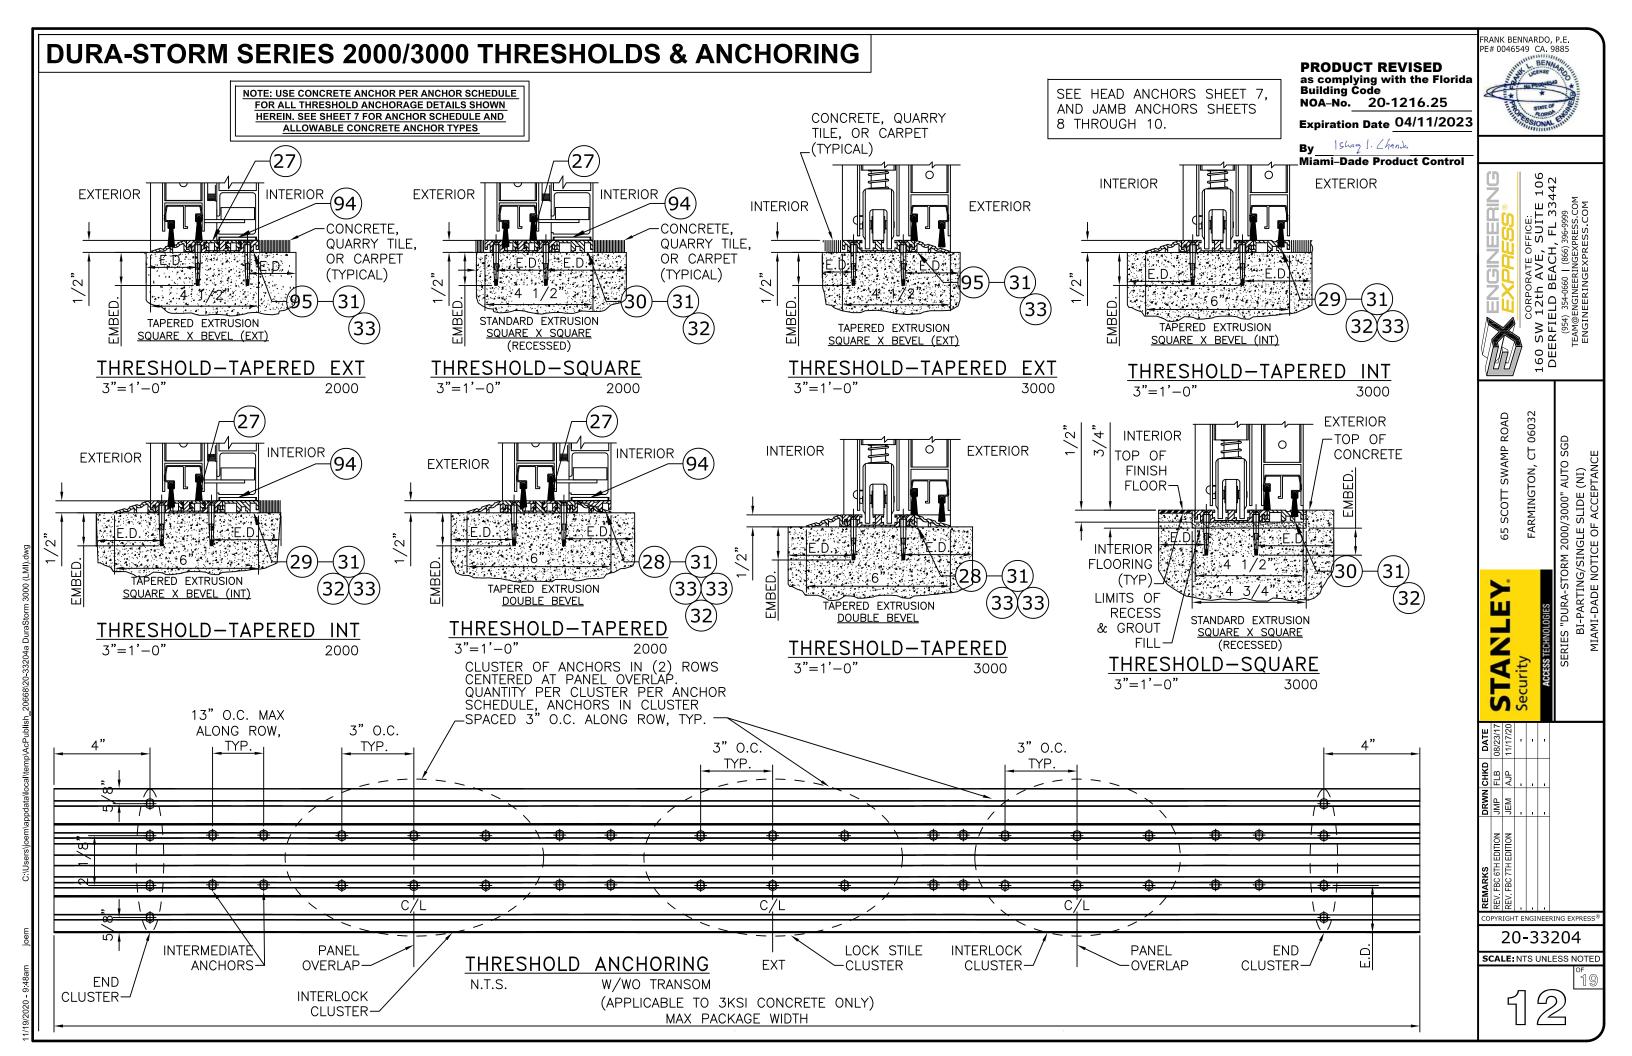

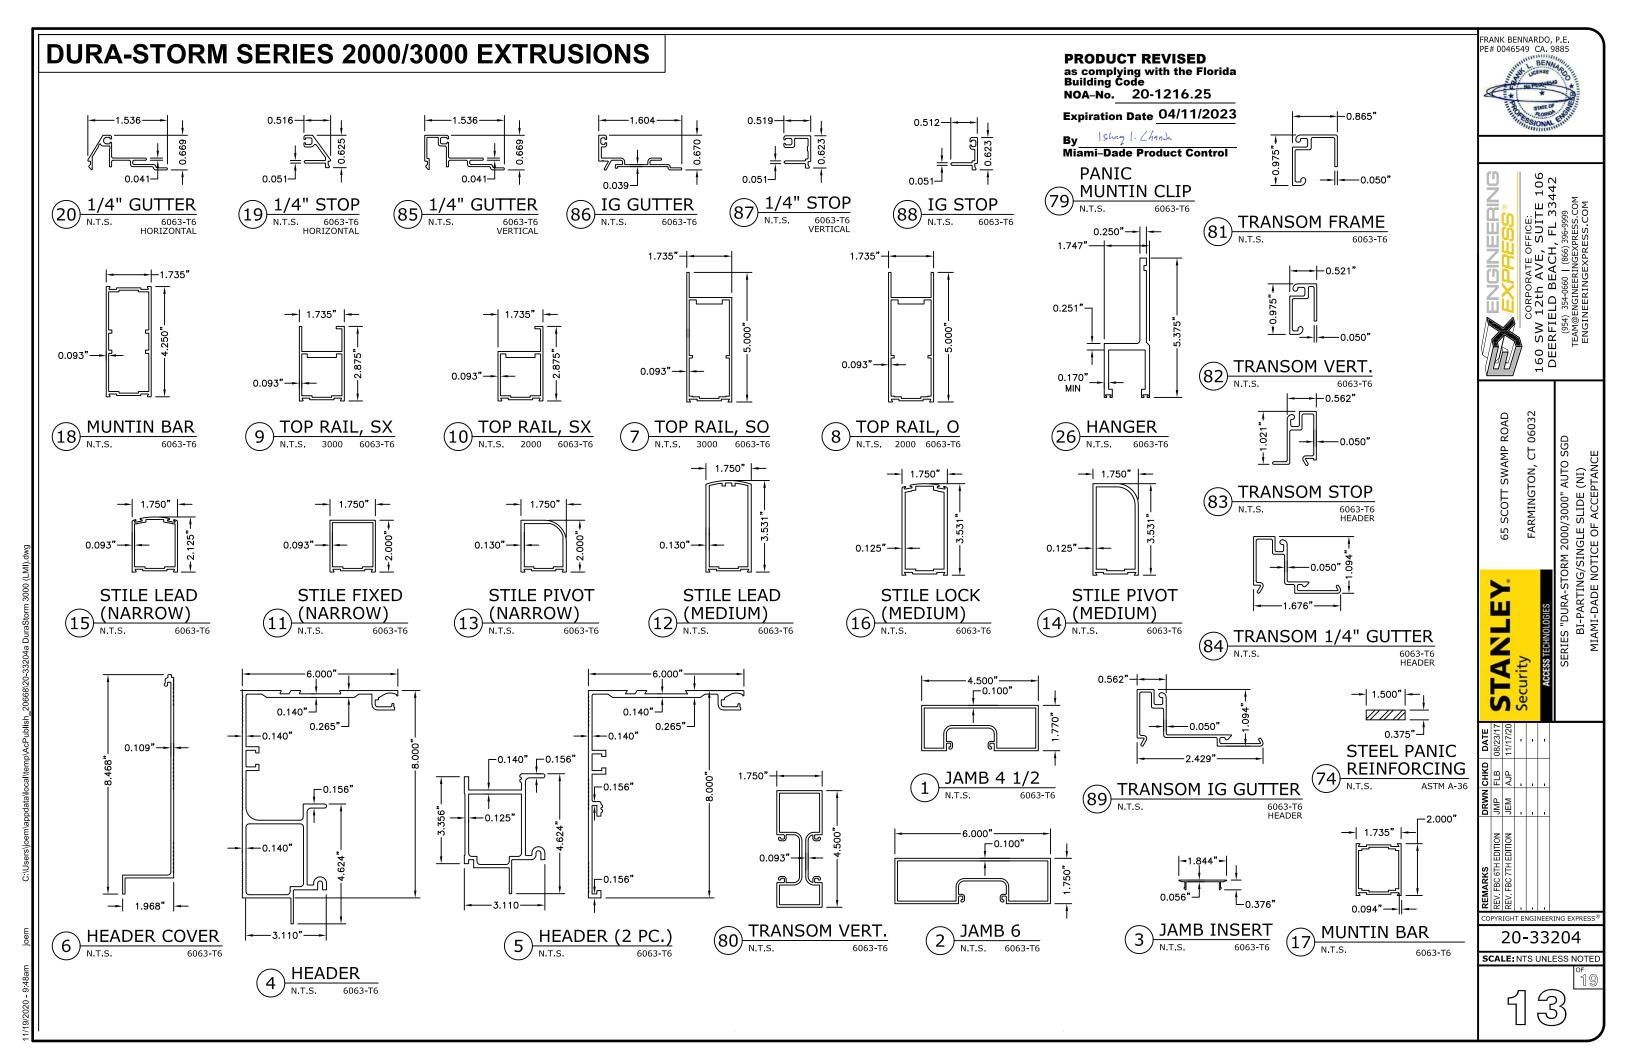

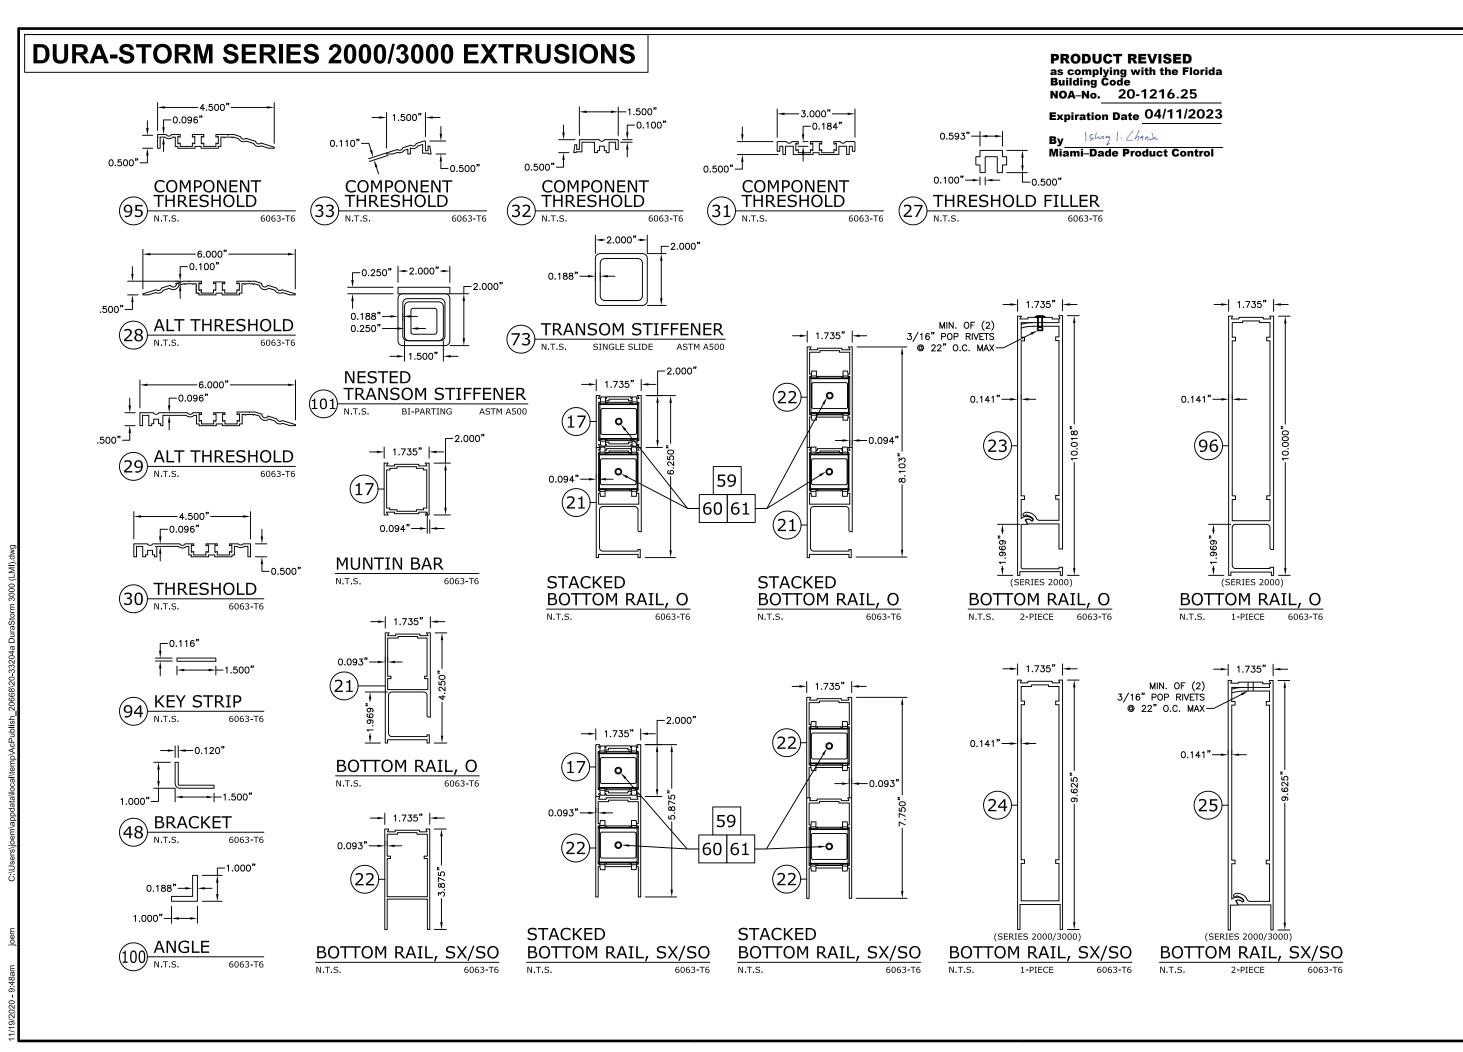

FRANK BENNARDO, P.E. PE# 0046549 CA. 9885

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. 06032 160 S

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SSTECHNOLOGIES
SERIES "DURA-STORM 2
BI-PARTING/SIN


11/17/20 Security Series "DURA Series"


REV. FBC TTH EDITION JAM AJP 11/17/17


20-33204

SCALE: NTS UNLESS NOTED


14

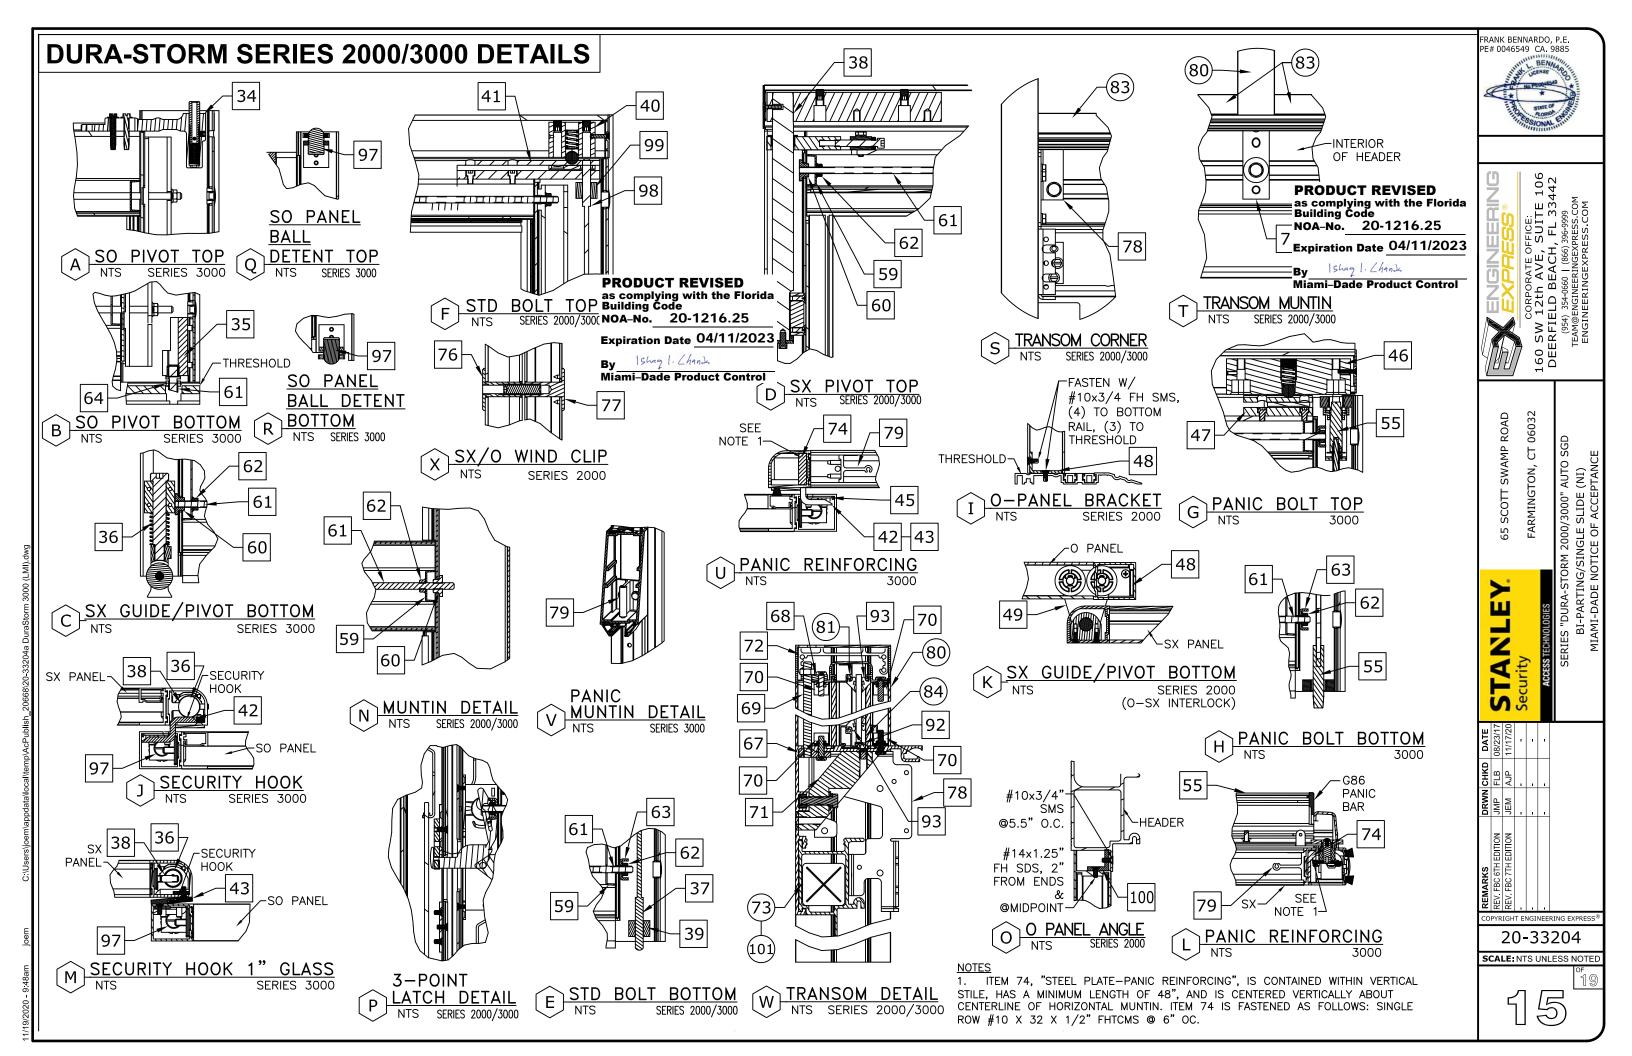

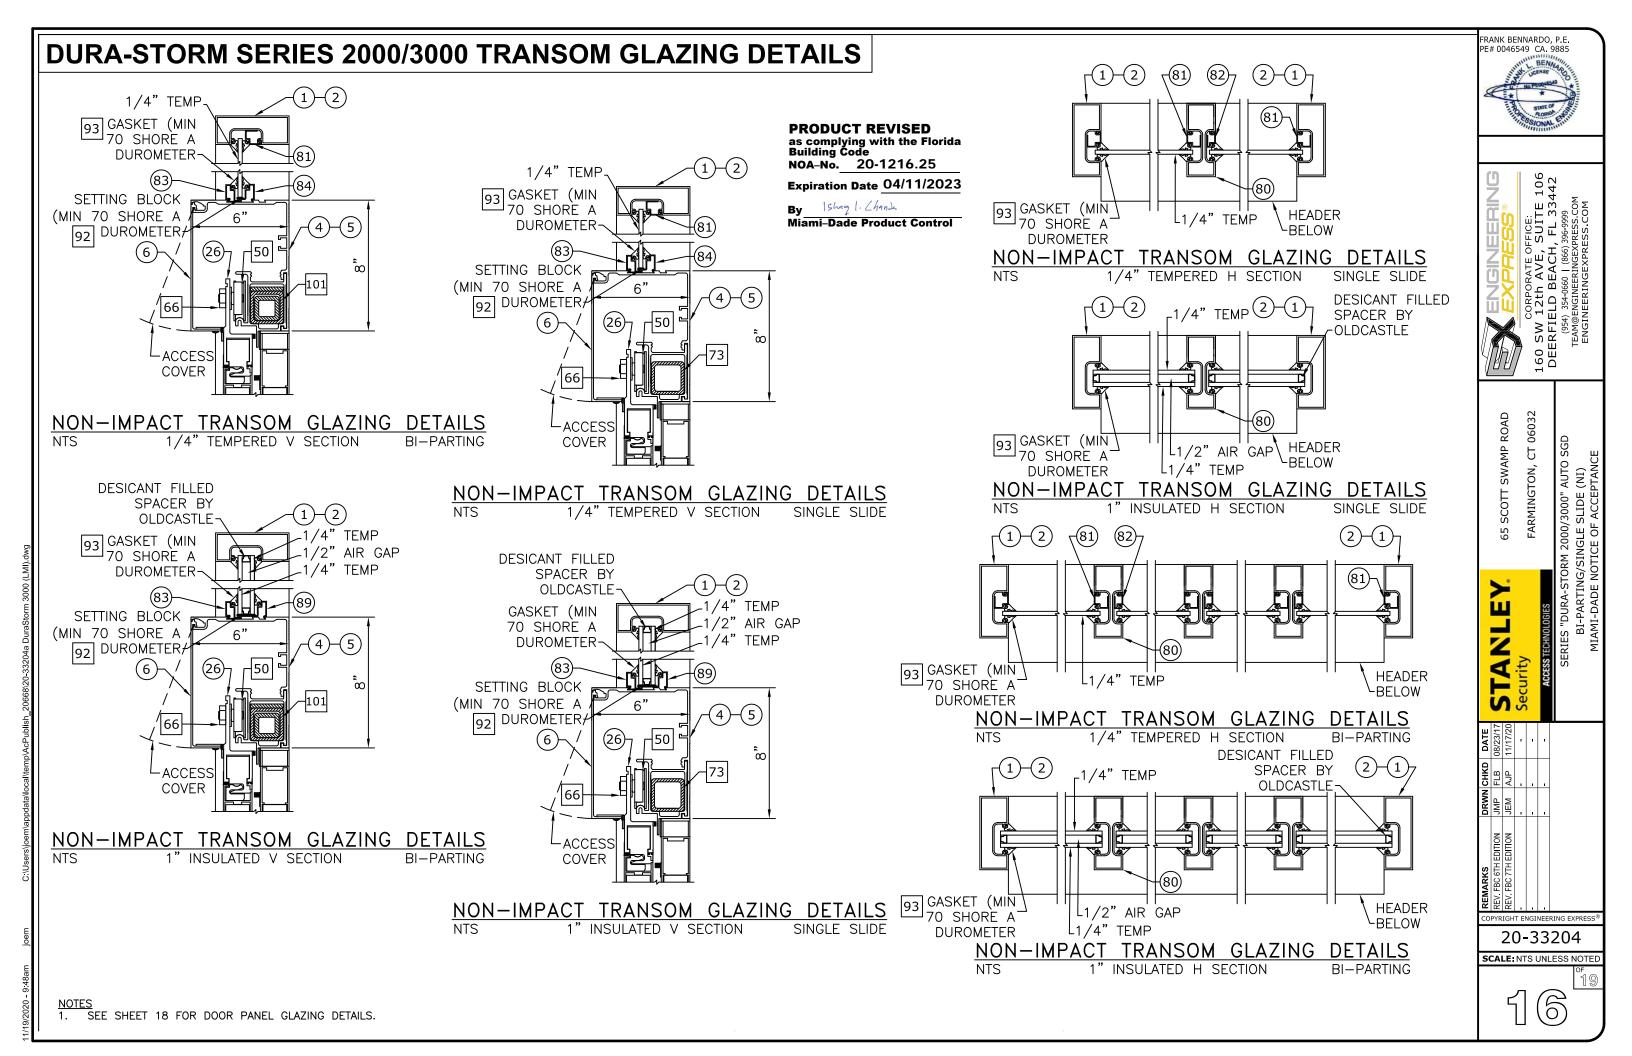


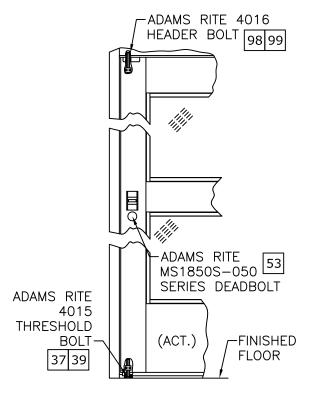


3-PT CONCEALED LOCKING SYSTEM SERIES 2000/3000 SINGLE SLIDE

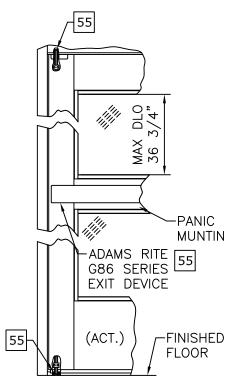

2-PT CONCEALED VERTICAL ROD WITH PANIC RELEASE LOCKING SYSTEM SERIES 3000 SINGLE SLIDE

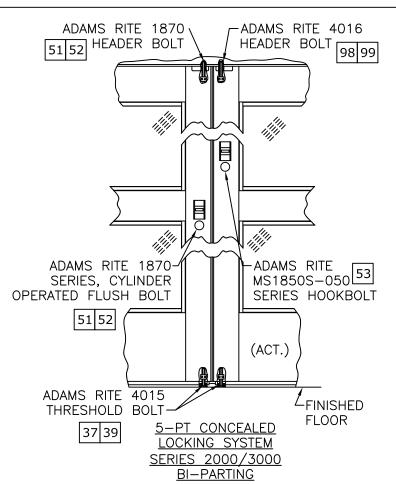

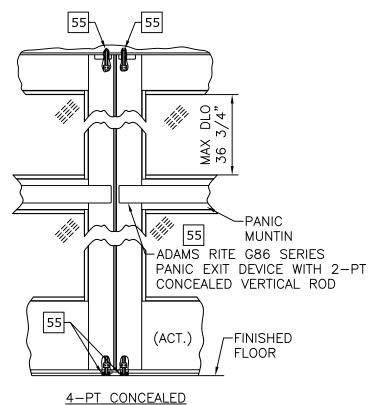


VERTICAL ROD WITH

PANIC RELEASE

LOCKING SYSTEM

SERIES 3000 **BI-PARTING**

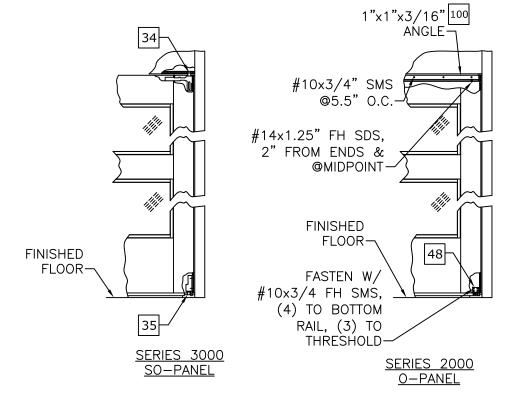

PRODUCT REVISED as complying with the Florida Building Code NOA-No. 20-1216.25

Expiration Date 04/11/2023

By Ishaq 1. Chands Miami-Dade Product Control




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TEAM@ENGINEERINGEXPRESS.COM
ENGINEERINGEXPRESS.COM

CT 06032 65 SCOTT SWAMP ROAD FARMINGTON,

T

20-33204 SCALE: NTS UNLESS NOTED

DURA-STORM SERIES 2000/3000 HORIZONTAL SECTION AND ANCHORING, TRANSOMS

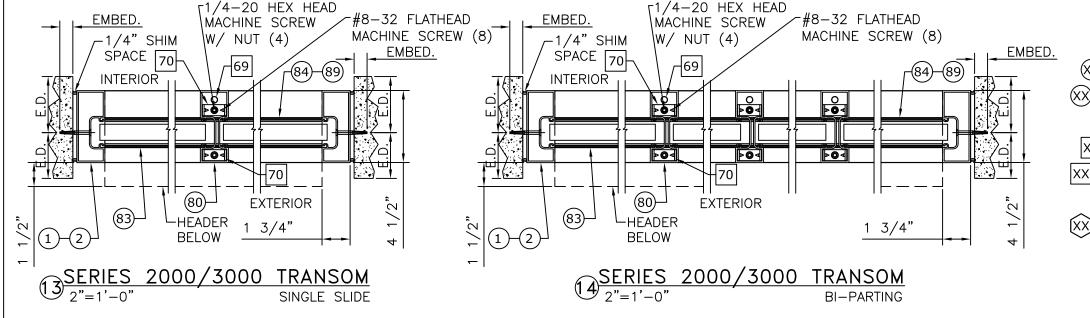

(XX): EXTRUSION

(XX)(XX): EXTRUSION, MULTI-PIECE

(XX)—(XX): EXTRUSION, OPTION

XX : PART

|XX|XX|: PART, MULTI-PIECE

|XX| + |XX|: PART, OPTION

(XX): DETAIL

(XX)-(XX): DETAIL, OPTION


PRODUCT REVISED
as complying with the Florida
Building Code
NOA-No. 20-1216.25

Expiration Date 04/11/2023

By Shap I. Chank
Miami-Dade Product Control

SEE HEAD ANCHORS SHEET 7, AND THRESHOLD ANCHORS SHEET 12. THRESHOLD ANCHORS APPLICABLE ONLY TO 3KSI CONCRETE.

DURA-STORM SERIES 2000/3000 DOOR PANEL GLAZING DETAILS

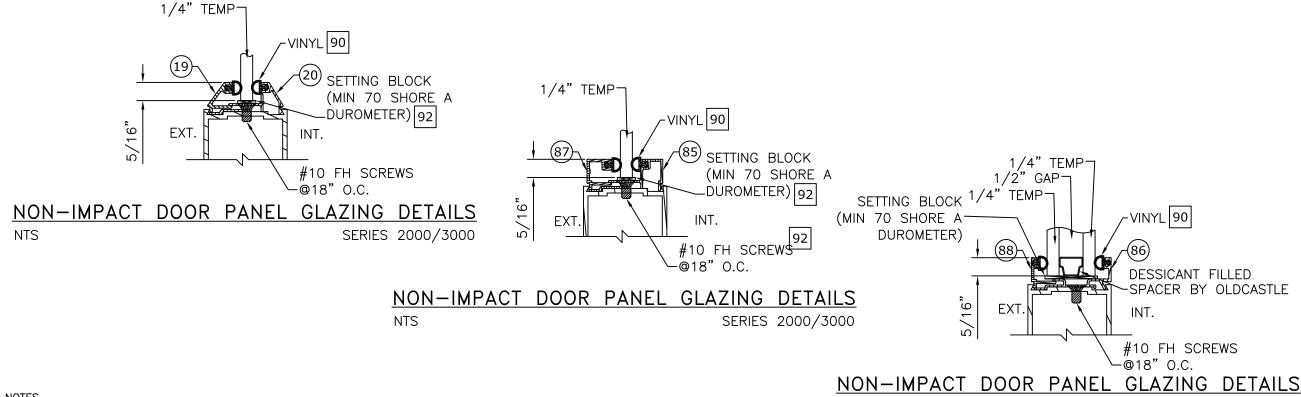

FRANK BENNARDO, P.E. PE# 0046549 CA. 9885

EXPRESS

CORPORATE OFFICE:

SW 12th AVE, SUITE 100

ERFIELD BEACH, FL 33442

(954) 334-969 (1865) 369-999

FARMINGTON, CT 06032

ACCESS TECHNOLOGIES

SERIES "DURA-STORM
BI-PARTING/SIN

4

REMARKS DRWN CHKD DATE
REV. FBC 6TH EDITION JEM AJP 11/17/20
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20-33204

SCALE: NTS UNLESS NOTED

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/19/2020 - 9:48am joen

<u>NOTES</u> . SEE SHEET 16 FOR TRANSOM GLAZING DETAILS.

NTS

NIS

SERIES 2000/3000

| | BILL OF MATERIALS |
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| | DILL OF MATERIALS |
| REFERENCE | DESCRIPTION |
| 1 | Extrusion - Jamb - 4 1/2" |
| 2 | Extrusion - Jamb - 6" |
| 3 | Extrusion - Jamb - Insert |
| 4 | Extrusion - Header - 1 PC |
| 5 | Extrusion - Header - 2 PC |
| 6 | Extrusion - Header Cover - |
| 7 | Extrusion - Top Rail - O, SO |
| 8 | Extrusion - Top Rail - O, SO |
| 9 | Extrusion - Top Rail - SX |
| 10 | Extrusion - Top Rail - SX |
| 11 | Extrusion - Stile - Fixed |
| 13 | Extrusion - Stile - Lead Extrusion - Stile - Pivot |
| 14 | Extrusion - Stile - Pivot |
| 15 | Extrusion - Stile - Lead |
| 16 | Extrusion - Stile - Lock |
| 17 | Extrusion - Muntin Bar/Stacked Bottom Rail Part - 2" |
| 18 | Extrusion - Muntin Bar - 4 1/4" |
| 19 | Extrusion - Panel Glass Stop - 1/4" - Horizontal |
| 20 | Extrusion - Panel Glass Gutter - 1/4" - Horizontal |
| 21 | Extrusion - Bottom Rail O - 4" |
| 22 | Extrusion - Bottom Rail SO/SX4" |
| 23 | Extrusion - Bottom Rail O - 10" - 2 PC |
| 24 | Extrusion - Bottom Rail SX/SO - 1 PC - 10" |
| 25 | Extrusion - Bottom Rail SX/SO - 2 PC - 10" |
| 26 | Extrusion - Hanger - |
| 27 | Extrusion - Threshold - Filler |
| 28 | Extrusion - Threshold - Dbl bevel - 6" Extrusion - Threshold - Sq/Bvl - 6" |
| 30 | Extrusion - Threshold - Sq/BVI - 6 Extrusion - Threshold - Recessed - 4.5" |
| 31 | Extrusion - Threshold - Recessed - 4.5 Extrusion - Threshold - Core |
| 32 | Extrusion - Threshold - Square |
| 33 | Extrusion - Threshold - Bevel |
| 34 | Component - Top Pivot - SO - 3000 |
| 35 | Component - Bottom Pivot - SO - 3000 |
| 36 | Component - Bottom Guide - SX- 2000/3000 |
| 37 | Component - Throw Bolt - Std - Adams Rite 4015 |
| 38 | Component - Top pivot - SX |
| 39 | Component - Guide - Throw Bolt - Adams Rite 4015 |
| 40 | Component - Ball Detent - Std |
| 41 | Component - Detent Block - Std |
| 42 | Component - Security Hook - Std |
| 43 | Component - Security Hook - 1" Glass |
| 45 | Component - Backing Plate - Security Hook |
| 46 | Component - Ball Detent |
| 47 | Component - Detent Block |
| 48 | Component - Bracket - O Panel |
| 49 | Component - Bottom Guide - SX - 2000 |
| 50 | Component - Load Wheel - Steel/Aluminum/Plastic |
| 51 | Component - Lock - Cylinder - Adams Rite 1870 (2-PT Lock) or Adams Rite MS1850S-050 (3-PT Lock) |
| 52 | Component - Lock - Thumb Turn - Adams Rite 1870 (2-PT Lock) or Adams Rite MS1850S-050 (3-PT Lock) |

| 79 | Component - Muntin Clip (with Panic) |
|-----|--|
| 80 | Extrusion - Transom - Vertical Muntin |
| 81 | Extrusion - Transom - Frame Stop - 1/4" |
| 82 | Extrusion - Transom - Vertical Muntin Stop - 1/4" |
| 83 | Extrusion - Transom - Header Stop |
| 84 | Extrusion - Transom - Header Gutter - 1/4" |
| 85 | Extrusion - Panel Glass Gutter - 1/4" - Vertical |
| 86 | Extrusion - Panel Glass Gutter - 1" |
| 87 | Extrusion - Panel Glass Stop - 1/4" - Vertical |
| 88 | Extrusion - Panel Glass Stop - 1" |
| 89 | Extrusion - Transom - Header Gutter - 1" |
| 90 | Glazing - Vinyl Bulb - 0.200" |
| 91 | Glazing - Vinyl Bulb - 0.262" |
| 92 | Glazing - Setting Block - |
| 93 | Glazing - Gasket - Transom |
| 94 | Extrusion - Key Strip |
| 95 | Extrusion - Threshold - Sq/Bvl - 4.5" |
| 96 | Extrusion - Bottom Rail O - 10" |
| 97 | Component - Ball Detent - SO |
| 98 | Component - Throw Bolt - Std - Adams Rite 4016 |
| 99 | Component - Guide - Throw Bolt - Adams Rite 4016 |
| 100 | Extrusion - 1"x1"x3/16" Angle |
| 101 | Nested Tube - Transom Stiffener - Bi-Parting - Steel (w, Optional Transom) |

BILL OF MATERIALS REFERENCE DESCRIPTION Component - 8 Ply Multipoint Lock - Single Action -53 Adams Rite MS1850S-050 (Deadbolt), Used w/ Adams Rite 4015 and 4016 Bolts 54 Component - Exit Indicator -Component - 2-Pt Panic Device - Adams Rite G86 with 55 concealed vertical rod (top/bottom) and latch assembly. 56 Component - Pile - Adhesive/non Adhesive backed Component - Brush - Sweep 57 58 Component - Foam Block -59 Hardware - Tie Rod - Plate 60 Hardware - Tie Rod - Nut - 5/16-18 - Steel Hardware - Threaded Rod - 5/16-18 - Steel 61 62 Hardware - 5/16 - 18 - Nut - Steel 63 Hardware - Tie Rod / Rail - Plate - Steel Hardware - 7/16-20 Jamb Nut - Steel 64 65 Hardware - 7/16 SO Pivot Pin - Steel 66 Hardware - 5/8-11 Nut - Steel 67 Hardware - Tie Rod - Nut Plate 68 Hardware - Tie Rod - Top Clip 69 Hardware - Tie Rod - 3/8-16 70 Hardware - Transom Clip - Steel 71 Hardware - Stiffener - Steel - A500 72 Hardware - Transom Clip - Aluminum Tube - Transom Stiffener - Single Slide - Steel (w/ 73 Optional Transom) Component - Steel Plate - Panic Reinforcing (48" Min.) 74 75 Component - Key Operator - Adams Rite 76 Component - Lock Flange (Int) - "Wind Clip' 77 Component - Lock Flange (Ext) - "Wind Clip' 78 Component - Header End Plate Component - Muntin Clip (with Panic)

PRODUCT REVISED as complying with the Florida Building Code NOA-No. 20-1216.25

Expiration Date 04/11/2023

By Ishaq 1. Chank Miami-Dade Product Control FRANK BENNARDO, P.E. PE# 0046549 CA. 9885

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06032 \Box FARMINGTON,

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20-33204

SCALE: NTS UNLESS NOTED



NON-CALL OUT PART # 44 IS NOT PART OF BOM